

THE UNITED REPUBLIC OF TANZANIA
MINISTRY OF HEALTH, COMMUNITY DEVELOPMENT, GENDER,
ELDERLY AND CHILDREN



CONTRACT DOCUMENT

SHINYANGA REGIONAL REFERRAL HOSPITAL

CONTRACT NUMBER: ME/SRRH/007/2021/2022W/08

FOR

PROVISION OF LABOUR FOR PROPOSED CONSTRUCTION OF X-RAY AND CT-SCAN
BUILDING AT SHINYANGA REGIONAL REFERRAL HOSPITAL

EMPLOYER :

Medical Officer Incharge,
Shinyanga Regional Referral Hospital,
P.O.Box 17,
SHINYANGA

CONTRACTOR:

Ntungamo Investment Company Ltd
P.O.Box 2193
SHINYANGA.

MARCH 2022

Appendix B: Key Personnel

3. The mutual rights and obligations of the Employer and the Service Provider shall be as set forth in the Contract, in particular:
 - a) The Service Provider shall carry out the Services in accordance with the provisions of the Contract; and
 - b) the Employer shall make payments to the Service Provider in accordance with the provisions of the Contract.

IN WITNESS WHEREOF, the Parties hereto have caused this Contract to be signed in their respective names as of the day and year first above written.

SIGNED by the said the Medical Officer In charge Shinyanga Regional Referral Hospital P. O. Box 17 SHINYANGA For and on behalf of *Employer*:

Name Dr. Richard Mhango

Signature Biel

Occupation Ag mto

Date 24/03/2022

In the Presence of:

Name: Beatrice Cheyo

Signature Enege

Designation HOD



SIGNED by the said Managing Director, Ntungamo Investment Company Ltd, P.O. Box 2193 SHINYANGA for and on behalf of *the Service Provider*:

Name Gervas Moland Kumpelga

Signature Moland

Occupation AG M-D


Date 24/03/2023

In the Presence of:

Name Kate Leopold

Signature Leopold

Designation Fundi

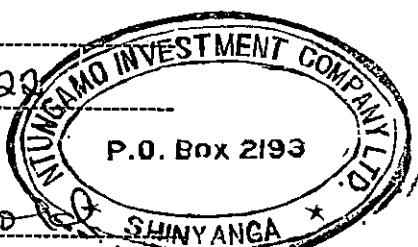

SHINYANGA REGIONAL REFERRAL HOSPITAL

Telegrams "AFYA" Shinyanga
Phone No: 028 -2763283
Fax No: 028 - 2763283
Email: nshinyangarrh@afya.go.tz



Regional Referral Hospital
P.O.BOX 17,
Shinyanga .
22.03.2022.

LETTER OF ACCEPTANCE:

TO: M/S NTUNGAMO INVESTMENT COMPANY LTD,
P.O.BOX 2193,
SHINYANGA.

RE: PROVISION OF LABOUR FOR PROPOSED CONSTRUCTION OF X-RAY AND
CT-SCAN BUILDING AT SHINYANGA REGIONAL REFERRAL HOSPITAL:

This is to notify you that your quotation dated March, 2022 for the Provision of Labour for Proposed Construction of X-Ray and Ct-Scan Building at Shinyanga Regional Referral Hospital for the contract price of Tshs 55,365,000 (Fifty-five million three hundred sixty-five thousand only) as corrected and modified in accordance with the instruction to Bidder is hereby accepted by our agency.

You are required to sign the contract Agreement and commence the services as you will be instructed from the date of signing the contract.

..... *Bon*

Dr.Richard Mhangwa


Acting:Medical Officer Incharge

Shinyanga Regional Referral Hospital


MEDICAL OFFICER INCHARGE
SHINYANGA REGIONAL REFERRAL
HOSPITAL

SECTION IV: GENERAL CONDITIONS OF CONTRACT


**GHARAMA ZA AWALI (PRELIMINARIES) JENGO LA
RADIOLOJIA-SCHEDULE OF LABOUR**

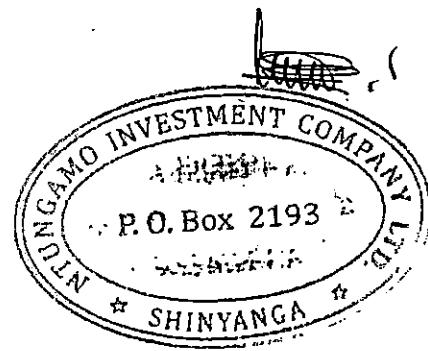

Na	MAELEZO YA KAZI	Tsh
B	Kuchimba mashimo, kusimika mirunda, kumwaga zege,kugongelea mbao pamoja na bati pamoja na kuezeka kwenye store ya kuhifadhi material site, wastani wa (5x4)m	300,000/-
C	Kuweka screed floor kwenye store ya wastani wa 5x4m	100,000/-
	Kuweka screed floor kwenye store ya wastani wa 5x4m	100,000/-
E	Kufunga milango ya bati kwenye store.	50,000/-
	JUMLA	550,000/-

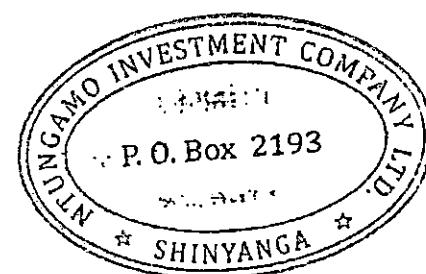


GHARAMA ZA UFUNDI WA JENGO LA RADILOJIA

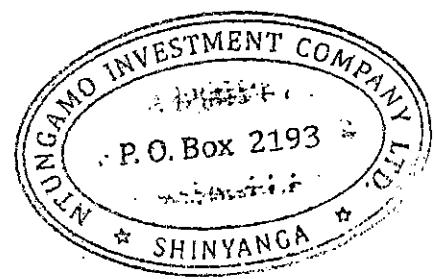

**GHARAMA ZA UFUNDI UJENZI WA JENGO LA RADILOJIA-HOSPITALI
YA RUFAA YASHINYANGA RRH**


Na	AINA YA KAZI	BEI YA UFUNDI
1	Msingi wa Jengo (sub structure)	
i	Kusafisha eneo kwa kuondoa miti, visiki na kutoa uchafu eneo la ujenzi (257m ²)	300,000/-
ii	Kuchimba na kuondoa udongo wa mweusi (rutuba) wastani wa 150mm (257m ²)	300,000/-
i	Kuseti jengo	400,000/-
ii	Uchimbaji wa msingi (isizidi 1.5m)-50m ³	450,000/-
	Uchimbaji wa mashimo ya nguzo (isizidi 1.5m)-1m ³	200,000/-
ii	Kuvunja Mawe kama yapo	150,000/-
iii	Kufukia na kushindilia msingi -23m ³	250,000/-
	Kuondoa kifusi kilichozidi na kisichohitajika eneo la ujenzi-28m ³	200,000/-
B	Usukaji wa nondo katika	
i	Kitako cha nguzo (column base) kulingana na mchoro	150,000/-
ii	Nguzo wa wima za msingi (column starter) kulingana na mchoro	200,000/-
iii	Nguzo mlalo za kwenye msingi (Ground beam) kulingana na mchoro.	1,200,000/-
C	Kufunga na kuondoa mbao	
i	Pembezoni mwa jamvi (60m)	800,000/-
ii	Pembezoni mwa nguzo wima za msingi, pembezoni mwa nguzo mlalo za msingi pamoja na pembedi mwa kitako cha nguzo (column base)-75m ²	750,000/-
D	Kumwaga zege	
i	Chini kwenye kitako cha msingi (strip foundation)-21m ³	2,000,000/-
ii	Chini kwenye kitakocha nguzo (column base)-1m ³	200,000/-
iii	Katika nguzo wima za awali (column starter)-1m ³	200,000/-
iv	Katika nguzo mlalo za kwenye msingi (ground beam)-8m ³	950,000/-

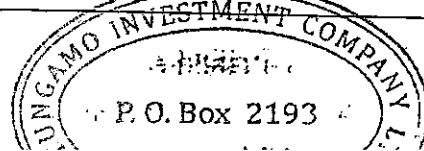

Signature

v	Kwenye jamvi (oversite concrete)-211m ²	3,000,000/-
vi	Katika njia panda (Ramp)-8m ²	500,000/-
vi	Umwagiliaji maji	200,000/-
E	Kuta za msingi	
i	Ujenzi wa kuta za msingi (tofali za kulala)-85m ²	1,200,000/-
F	Upangaji na ushindiliaji	
i	Upangaji wa mawe(178m ²) na utandazaji wa DPM (500gauge)-211m ²	750,000/-
ii	Uwekaji wa kifusi nkushindilia katika misingi,mashimo ya nguzo na na kwenye jamvi kutumia Kifusi kilichokubalika (300mm) - 178m ²	500,000/-
iii	Uwekaji wa sumu ya mchwa kwenye jamvi(178m ²) na pembezoni mwa kuta za msingi (21m)	100,000/-
	JUMLA KATIKA MSINGI WA JENGO (SUB STRUCTURE)	14,950,000/-


2	Kunyanya jengo (super structure)	
A	Kusuka nondo katika	
i	Nguzo wima Kutoka kwenye jamvi hadi katika nguzo mlaloza kupokea paa (roof beam)	200,000/-
ii	Kwenye nguzo mlalo	1,800,000/-
iii	Katika Ramp na ngazi (steps)	150,000/-
B	Kufunga na kuondoa mbao	
i	Katika nguzo wima Kutoka kwenye jamvi hadi kwenye nguzo mlalo za kupokea paa-16m ²	350,000/-
ii	Katika pande za wima za Nguzo mlalo za kupokea paa (Roof beam)-73m ²	800,000/-
	Kwa chini mwa Nguzo mlalo za kupokea paa (Roof beam)-26m	400,000/-
iv	Katika Ramp ngazi (steps) na Cill za madirisha 26m	500,000/-
C	Kumwaga zege	

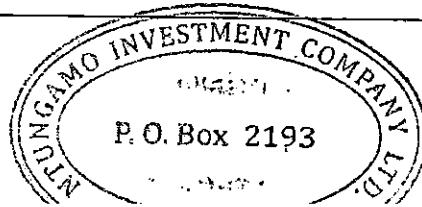

i	Katika nguzo wima Kutoka kwenye jamvi hadi kwenye nguzo mlao za kupokea paa (Roof beam)-1m ³	150,000/-
ii	Katika Nguzo mlao za kupokea paa (roof beams)-7m ³	1,500,000/-
iii	Katika Ramp na ngazi (steps)-1m ³	150,000/-
D	Ujenzi wa kuta	
i	Uwekaji wa DPC-108m	200,000/-
ii	Katika kuta za nje-82m ²	950,000/-
iii	Katika kuta za ndani-249m ²	2800,000/-
	JUMLA YA KUNYANYUA JENGO (SUPERSTRUCTURE)	9,950,000/-


3	Kuezeka (Roof structure)	
i	Kutengeneza kenchi za mbao kwa kufuata mchoro	600,000/-
ii	Kupandisha kenchi za mbao kwenye jengo	400,000/-
iii	Kuezeka-229m ²	1,100,000/-
iv	Kufunga matega maji (gutters & downpipes) kuzunguka jengo na kulingana na mchoro.	300,000/-
	JUMLA NDOGO KUEZEKA	2,400,000/-

4	MILANGO	
i	Kufitisha fremu za milango kulingana na mchoro -71m	250,000/-
ii	Kuweka urembo wa pembedi mwa fremu za mbao (Architrave)-65m	200,000/-
iii	Kufunga milango (shutters) pamoja na bawaba na Vitasa vyake vyote-9Nos	360,000/-
iv	Kufunga mlango wa Steel X-ray	300,000/-
v	Kuweka majina kwenye milango yote pamoja na Alama kwenye milango na maeneo yatakayotakiwa (Name plates and Signs)	500,000/-
	JUMLA NDOGO MILANGO	1,610,000/-

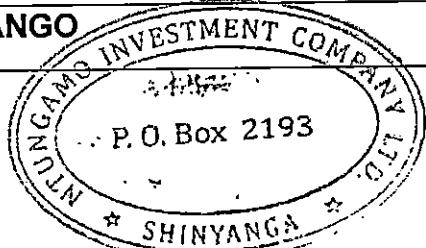


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5	MADIRSHA	
i	Kufitisha madirisha ya chuma (grill)-7 kulingana na vipimo	210,000/-
	JUMLA NDOGO MADIRISHA	210,000/-
6	UMALIZIAJI (Finishing)	
A	Upigaji wa lipu pamoja kutengeneza koplo	
i	Nje ya jengo-219m ²	1,200,000/-
ii	Ndani ya jengo-521m ²	2,150,000/-
iii	Nguzo wima-10m ²	200,000/-
iii	Kwenye kuta za Varanda-15m ²	250,000/-
iii	Kwenye nguzo mlalo (lenta)-9m ²	200,000/-
	Nguzo za mbele za jengo-15m ²	250,000/-
B	Vigae kwenye Sakafu	
i	Uwekaji wa sakafu ya kupokea vigae-211m ²	840,000/-
ii	Uwekaji wa vigae pamoja na grout katika sakafu (floor tiles)-211m ²	1,500,000/-
iii	Uwekaji wa vigae vya skirting-203m	350,000/-
iv	Uwekaji wa vigae kwenye ngazi-39m	200,000/-
v	Uwekaji wa vigae kwenye ngazi mlalo(Ramp)-11m ²	150,000/-
B	Vigae kwenye Ukuta	
	Uwekaji wa vigae pamoja grout katika kuta za vyooni na mabafuni (wall tiles)-101m ²	650,000/-
C	DARI	
i	Ufungaji wa mbao za dari (brandering) pamoja na gypsum bords -211m ²	1,200,000/-
ii	Ufungaji mikanda-266m	250,000/-
iii	Uwekaji wa mlango wa dari-1(mmoja)	30,000/-
	JUMLA NDOGO YA UMALIZIAJI JENGO (FINISHING)	9,420,000/-

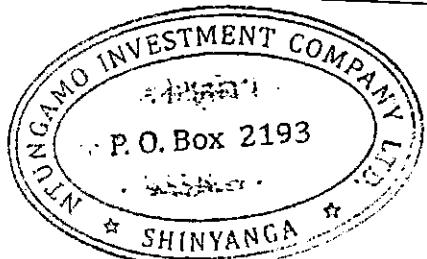

7	Rangi na Mapambo (painting & Decorations)	
A	Kupaka rangi ,mikono mitatu pamoja na Skimming	
	Nje ya jengo-219m ²	450,000/-
	Ndani ya jengo-789m ²	1,600,000/-
	Nguzo wimaza mbele-10m ²	50,000/-
	Kwenye kuta za Varanda-15m ²	100,000/-
	Kwenye nguzo mlalo (lenta)-11m ²	100,000/-
	Fremu za milango-51m	100,000/-
	Cill za madirisha-26m	150,000/-
	Kwenye dari-211m ²	400,000/-
B	Kupaka rangi ,mikono mitatu katika	
i	Msingi wa nyumba	150,000/-
ii	Fascia board na roof vent	50,000/-
iii	Madirisha ya chuma (grill)	250,000/-
	JUMLA NDOGO YA RANGI NA MAPAMBO	3,400,000/-
8	UMEME (electrical installation)	
i	Usukaji wa umeme awamu ya kwanza (conduit na box) hii ikujumuisha na pointi za DP za AC,ICT etc, pamoja na uwekaji wa panel zote kulingana na mchoro wa engineer wa services kulingana na mchoro	200,000/-
ii	Usukaji wa umeme awamu ya pili (2 nd fix) kulingana na mchoro	1500,000/-
iii	Ufungaji wa vifaa vyote vya umeme (fittings) kulingana na mchoro	1,000,000/-
iv	Kuandaa nyaraka za kukabidhi kazi kama Michoro ya kama ilivyojengwa,test results na ripoti za mafunzo ya utumiaji wa mfumo.	200,000/-
	JUMLA NDOGO UMEME (ELECTRICAL INSTALLATION)	3,000,000/-
10	ICT INSTALLATION	
i	Usukaji wa mfumo wa ICT (2 nd fix) kulingana na mchoro	500,000/-
ii	Ufungaji wa vifaa vyote vya ICT (fittings) kulingana na mchoro	1500,000/-

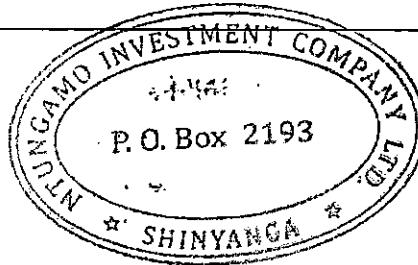

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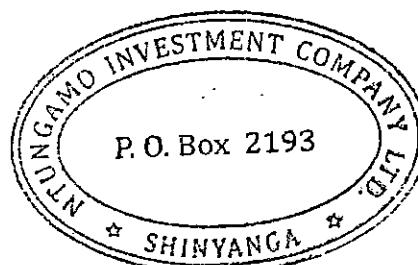
ii	Kuandaa nyaraka za kukabidhi kazi kama Michoro ya kama ilivyojengwa,test results na ripoti za mafunzo ya utumiaji wa mfumo.	300,000/-
	JUMLA NDOGO ICT INSTALLATION	2,300,000/-
11	AC INSTALLATION	
i	Uwekaji wa pipe za AC (Copper pipe) awamu ya kwanza.	500,000/-
ii	Ufungaji wa indoor na outdoor machines za AC pamoja na vifaa vingine vya AC kulingana na mchoro wa service engineer	800,000/-
iii	Kuandaa nyaraka za kukabidhi kazi kama Michoro ya kama ilivyojengwa,test results na ripoti za mafunzo ya utumiaji wa mfumo.	300,000/-
12	MIFUMO YA MAJI SAFI NA MAJI TAKA (WATER SUPPLY AND SEWERAGE SYSTEM).	
i	Ufungaji bomba awamu ya kwanza (kuchimbia bomba) 1 st fix	300,000/-
ii	Ufungaji wa vifaa vyote vya bomba (kama vyoo,HWB,shattaf,watertaps,soap holder nk)	400,000/-
iii	Kuunganisha maji kwenye jengo	500,000/-
iii	Uchimbaji wa wa mashimo ya maji taka (septic and soak away tanks	700,000/-
iv	Ujenzi wa mashimo ya taka pamoja na chembazake,kufitisha mifuniko yake ya chuma na kufanya finishings.	3,175,000/-
	JUMLA NDOGO MIFUMO YA MAJI SAFI NA MAJI TAKA	5,075,000/-
11	MIFUMO YA KUPMBANA NA MOTO (FIREFIGHTING SYSTEM).	
	Uandaaji wa mazingira ya uwekaji wa fire extinguisher	600,000/-
	Ufungaji wa Portable fire extinguishers	300,000/-
	<i>NB kazi hii ni specialized type of work</i>	
	JUMLA NDOGO YA MIFUMO YA KUPMBANA NA MOTO (FIREFIGHTING SYSTEM).	900,000/-





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SHINYANGA


SUMMARY YA JENGO LA RADIOLOJIA

A	Jumla ya gharama za awali (preliminaries)	550,000/-
B	GHARAMA ZA UFUNDI KWENYE JENGO	
1	Jumla katika msingi wa jengo (sub structure)	14,950,000/-
2	Jumla ya kunyanya jengo (superstructure)	9,950,000/-
3	Jumla ndogo kuezeka (Roofing and covering)	2,400,000/-
4	Jumla ndogo milango	1,610,000/-
5	Jumla ndogo madirisha	210,000/-
6	Jumla ndogo ya umalizaji jengo (finishing)	9,420,000/-
7	Jumla ndogo ya rangi na mapambo	3,400,000/-
8	Jumla ndogo umeme (electrical installation)	3,000,000/-
9	Jumla ndogo Tehama (ICT installation)	2,300,000/-
10	Jumla ndogo AC installation	1,600,000/-
11	Jumla ndogo mifumo ya maji safi na maji taka	5,075,000/-
12	Jumla ndogo ya mifumo ya Kupambana na moto	900,000/-
	JUMLA KUU YA GHARAMA ZA UFUNDI JENGO LA RADIOLOJIA	55,365,000/-



LEGEND - AIR CONDITIONING AND MECH. VENTILATION

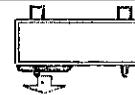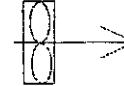
S/No.	DESCRIPTION	SYMBOLS
1.	Single split, Outdoor Unit	
2.	Indoor unit, wall mounted type	
3.	Extract Fan	
4.	Condensate Drainage pipe	
5.	Refrigerant pipe	

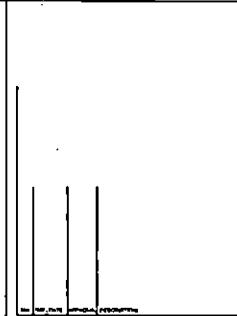

PROPOSED CONSTRUCTION OF X-RAY AND CT SCAN BUILDING

<input type="checkbox"/> FOR TENDER
<input type="checkbox"/> FOR INFORMATION
<input type="checkbox"/> FOR BUILDING PERMIT
<input type="checkbox"/> FOR APPROVAL
<input type="checkbox"/> FOR CONSTRUCTION

GROUP: 1
PROPOSED CONSTRUCTION OF X-RAY AND CT SCAN BUILDING

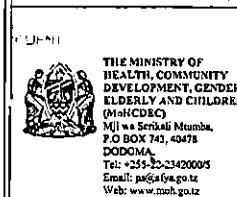



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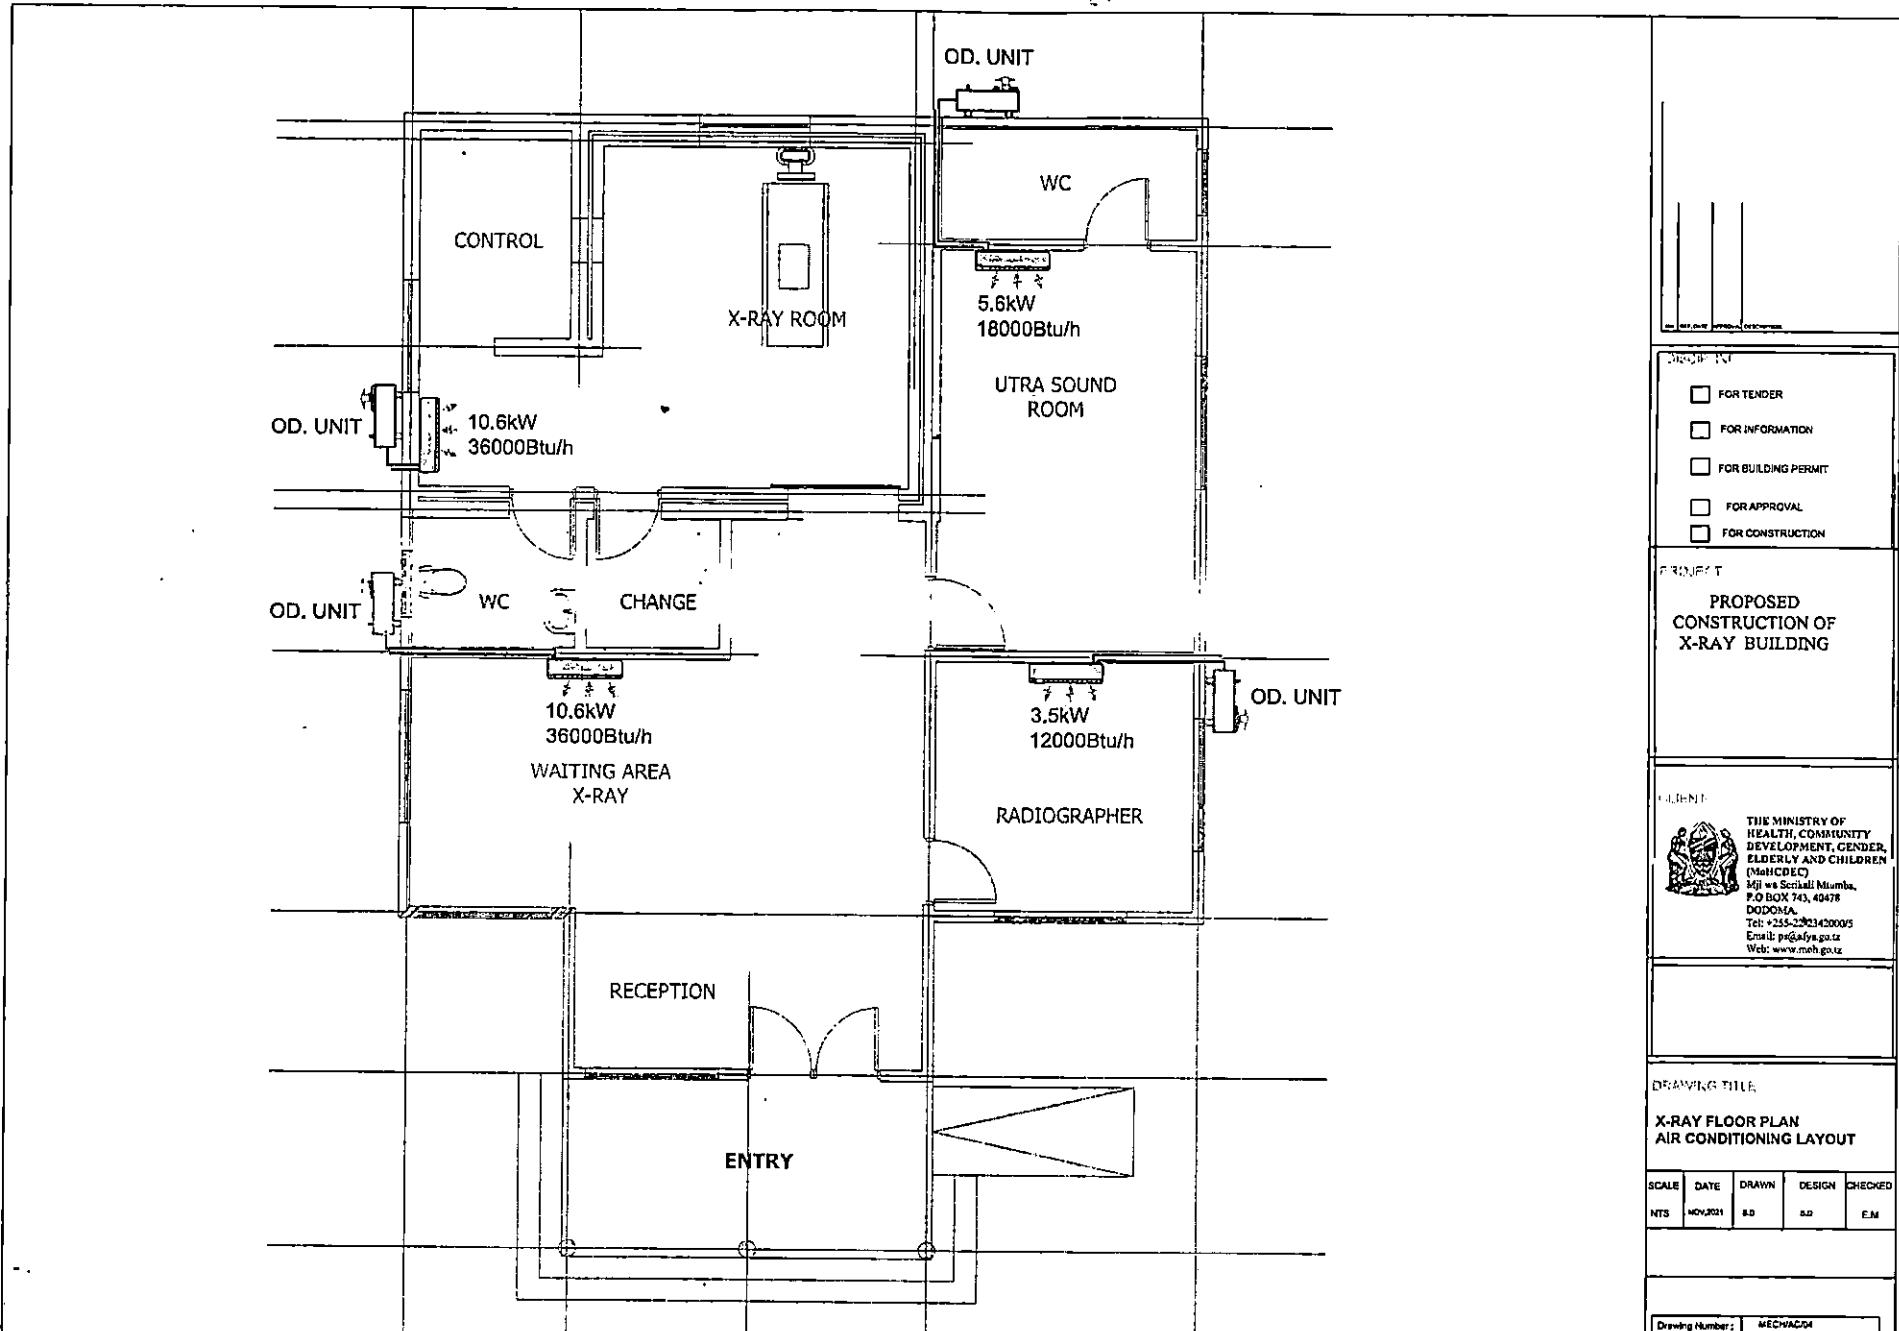
LEGEND
AIR CONDITIONING LAYOUT

SCALE	DATE	DRAWN	DESIGN	CHECKED
NTS	NOV.2021	R.D.	R.D.	E.M.

Drawing Number: 1 Revision No.: 1



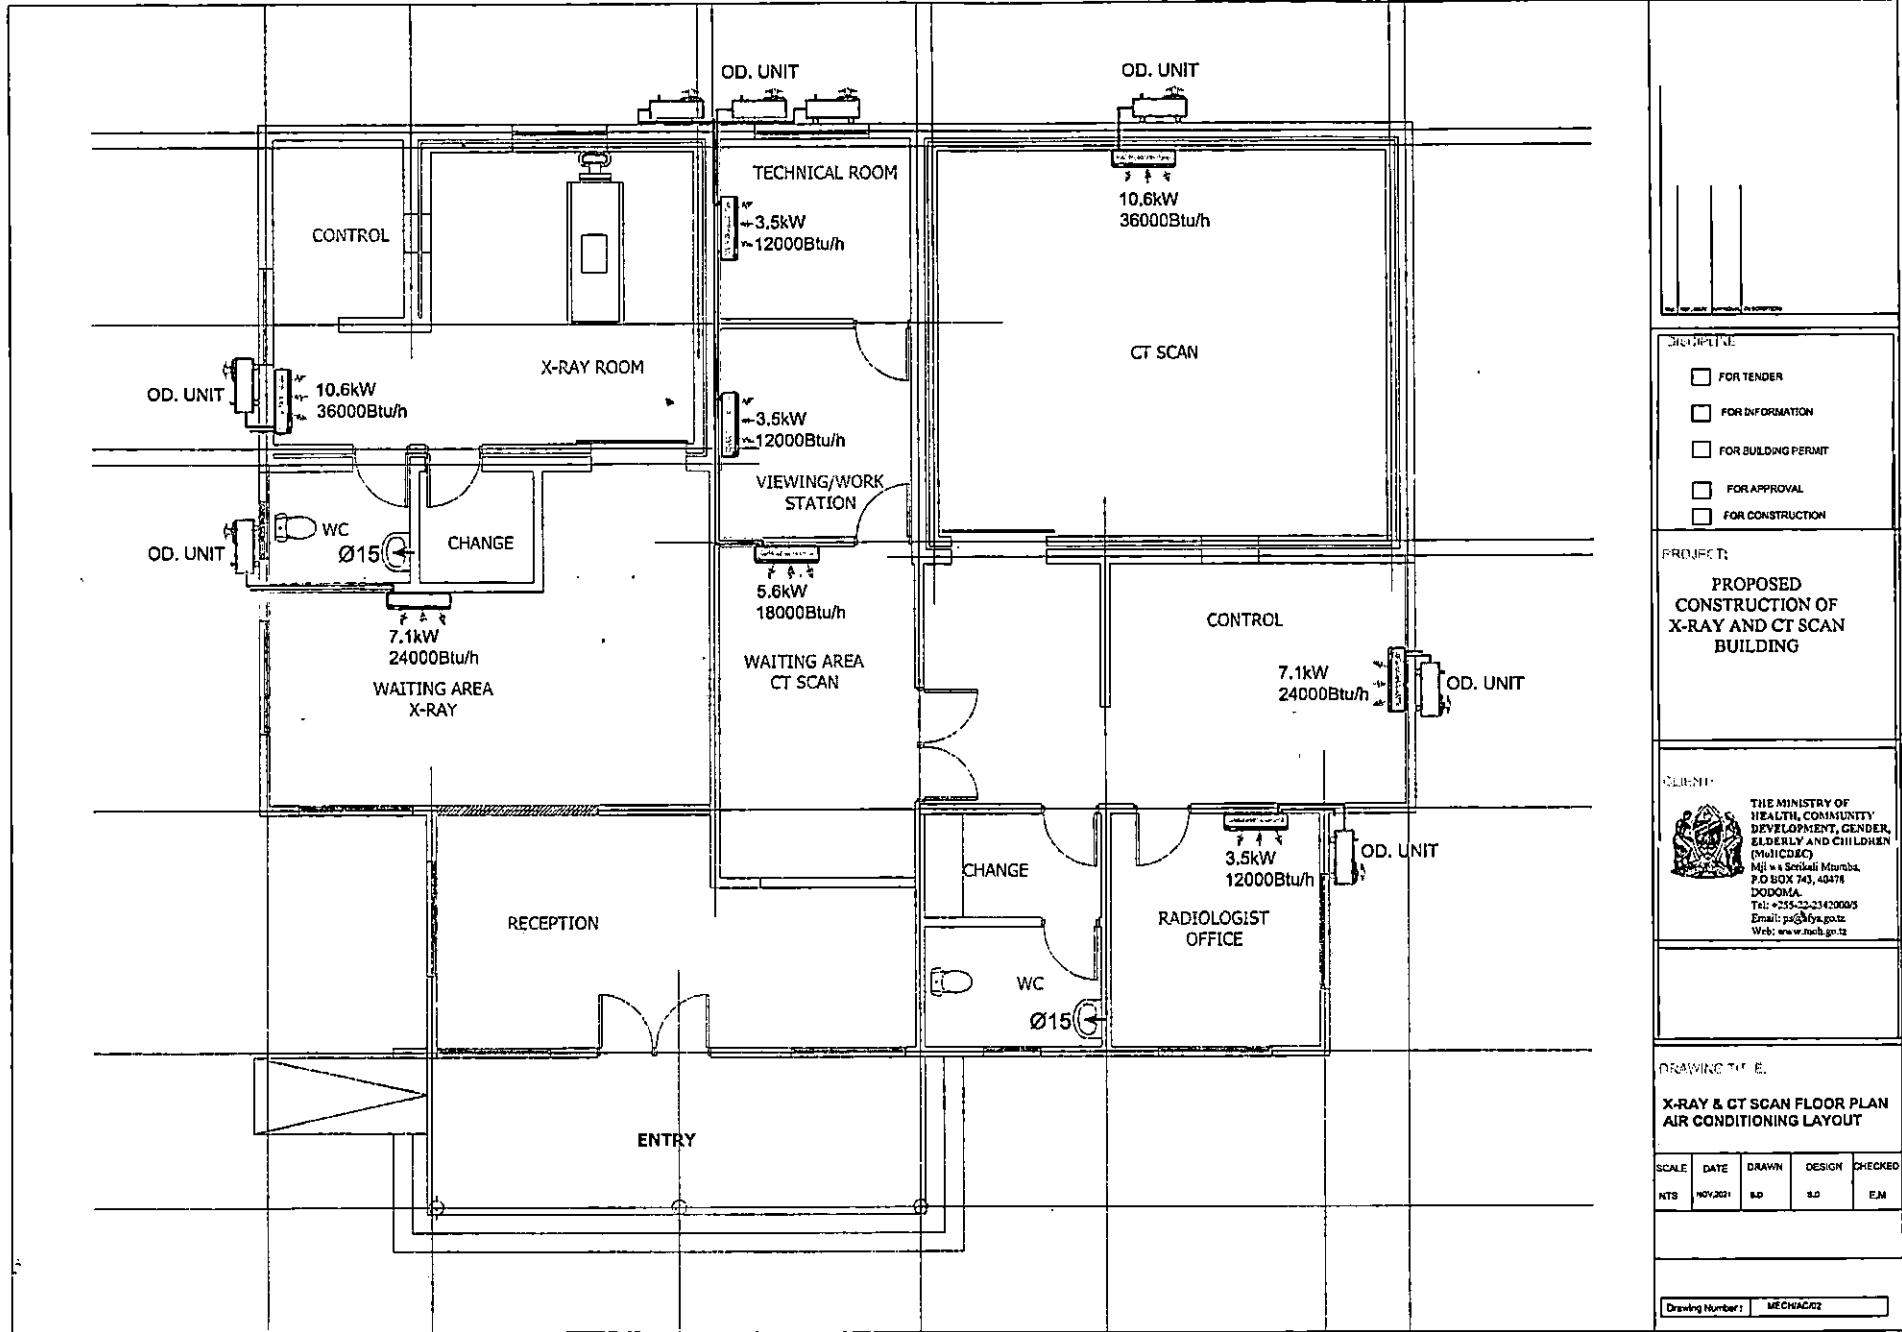

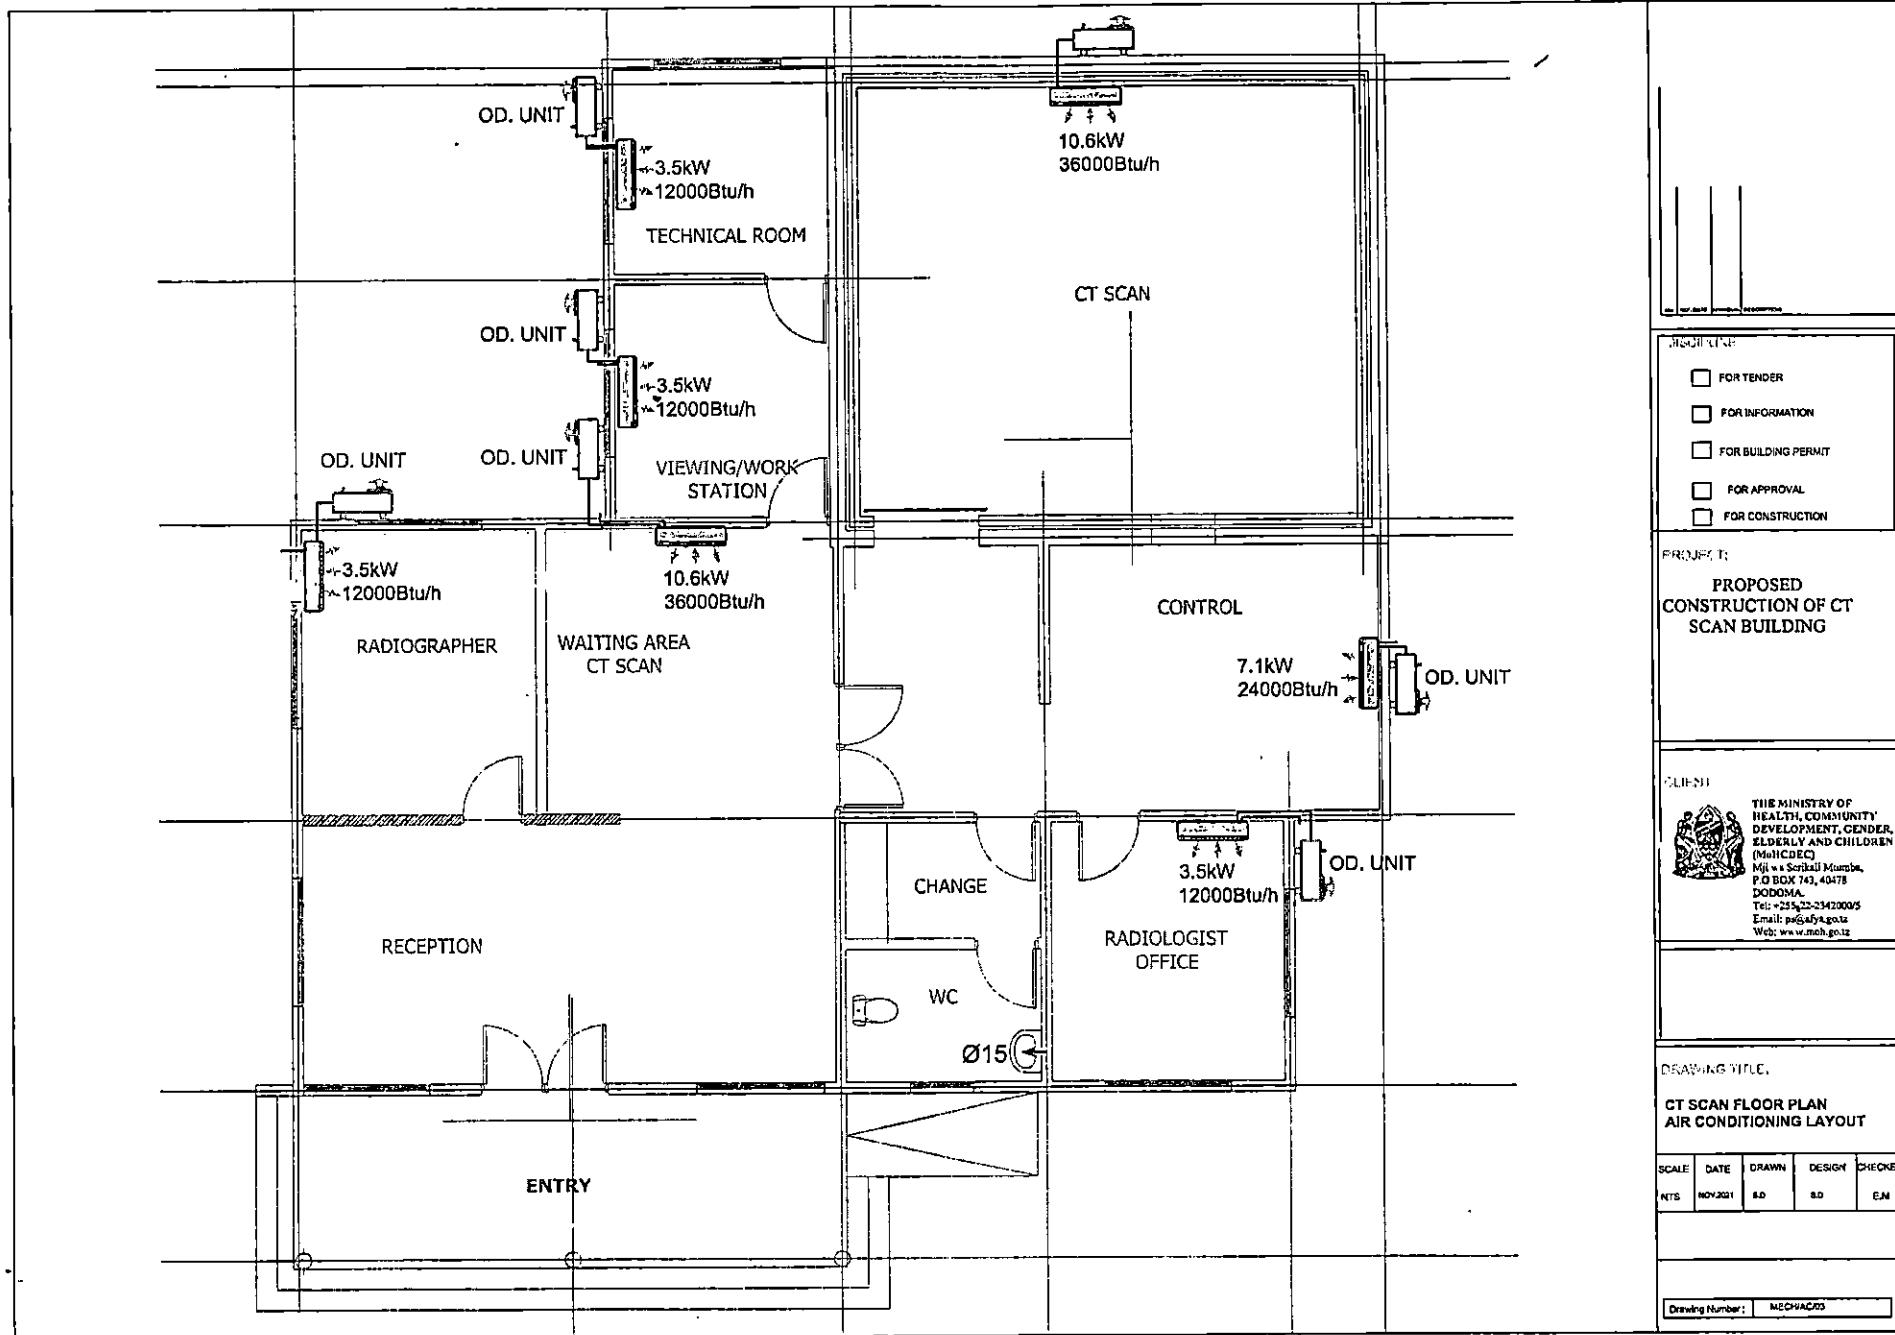


LEGEND:

WATER SUPPLY INSTALLATION SYMBOLS

S/No.	SYMBOL/ABREV.	DESCRIPTION
1.	○ ⊖	MOTOR (PUMP)
2.	⊗	GATE VALVE
3.	▷	NON-RETURN VALVE
4.	—	COLD WATER SUPPLY PIPE - PPR

NOTES

1. ALL PIPES, JOINTS, VALVES AND OTHER ACCESSORIES TO BE PPR (DIZAYN).
2. PIPE SIZE:
 - # All water supply pipes should be complying with BS 6700-1987.
 - # Pipes to WC, HWB, and UR are Ø15mm.
 - # Distribution pipes should be Ø40, Ø32, Ø25 and Ø20mm.

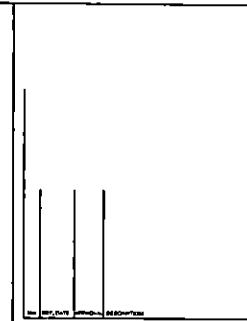

STANDARD
<input type="checkbox"/> FOR TENDER
<input type="checkbox"/> FOR INFORMATION
<input type="checkbox"/> FOR BUILDING PERMIT
<input type="checkbox"/> FOR APPROVAL
<input type="checkbox"/> FOR CONSTRUCTION


PROJECT
PROPOSED CONSTRUCTION OF X-RAY AND CT SCAN BUILDING

CLIENT
 THE MINISTRY OF HEALTH, COMMUNITY DEVELOPMENT, GENDER, ELDERLY AND CHILDREN (MoHCEC) Mji wa Serikali Mombasa, P.O BOX 743, 40478 DODOMA. Tel: +254-22-23420005 Email: pgs@mohc.go.tz Web: www.msh.go.tz

DRAWING TITLE
LEGEND WATER SUPPLY LAYOUT

SCALE	DATE	DRAWN	DESIGN	CHECKED
NTS	NOV/2011	GD	SD	EM

Drawing Number:	MECH/W3/01
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Ø25 C/W PIPE FROM
WATER SOURCE

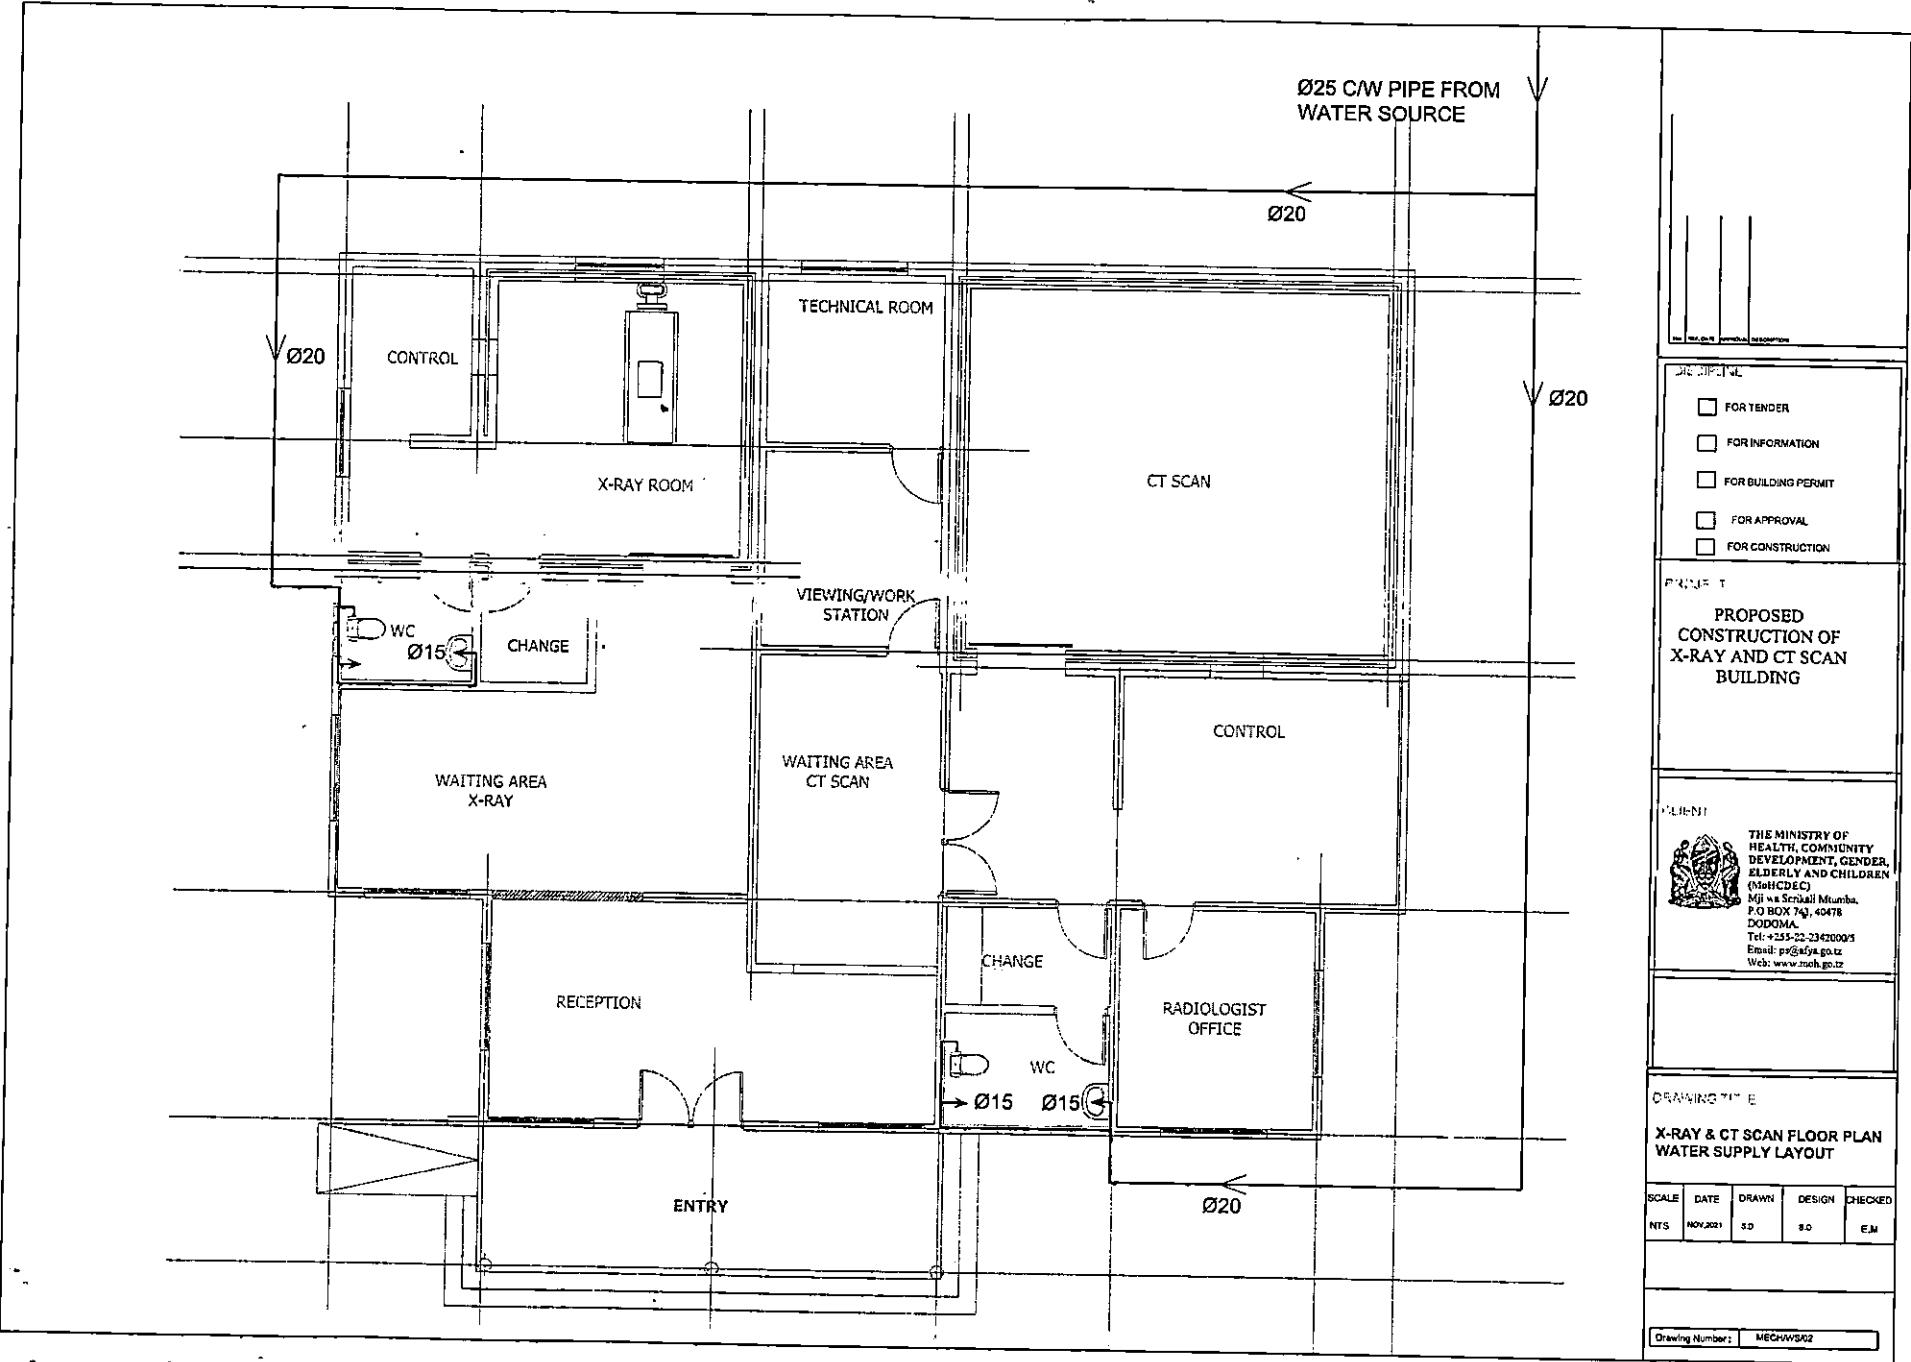020

92

Ø20 | CONTROL

X-RAY ROOM

TECHNICAL ROOM

CT SCAN

**WAITING AREA
X-RAY**

WAITING AREA

CHANGE

**VIEWING/WC
STATION**

WAITING ARE
CT SCAN

CONTRO

RECEPTION

ENTR

RADIOLOGIST
OFFICE

02

- FOR TENDER
 - FOR INFORMATION
 - FOR BUILDING PERMIT
 - FOR APPROVAL
 - FOR CONSTRUCTION

**PROPOSED
CONSTRUCTION OF
X-RAY AND CT SCAN
BUILDING**




THE MINISTRY OF
HEALTH, COMMUNITY
DEVELOPMENT, GENDER
AND CHILDREN
(MoHCDEC)
P.O. Box 743, 40478
ODOMA.
Tel: +251-22-2342000/3
Email: ps@afya.gov.tz
www.moh.gov.tz


DRAWING NO. E

X-RAY & CT SCAN FLOOR PLAN
WATER SUPPLY LAYOUT

SCALE	DATE	DRAWN	DESIGN	CHECKED
NTS	NOV.2021	5.0	5.0	E.M.

Drawing Number: MECHW5A02

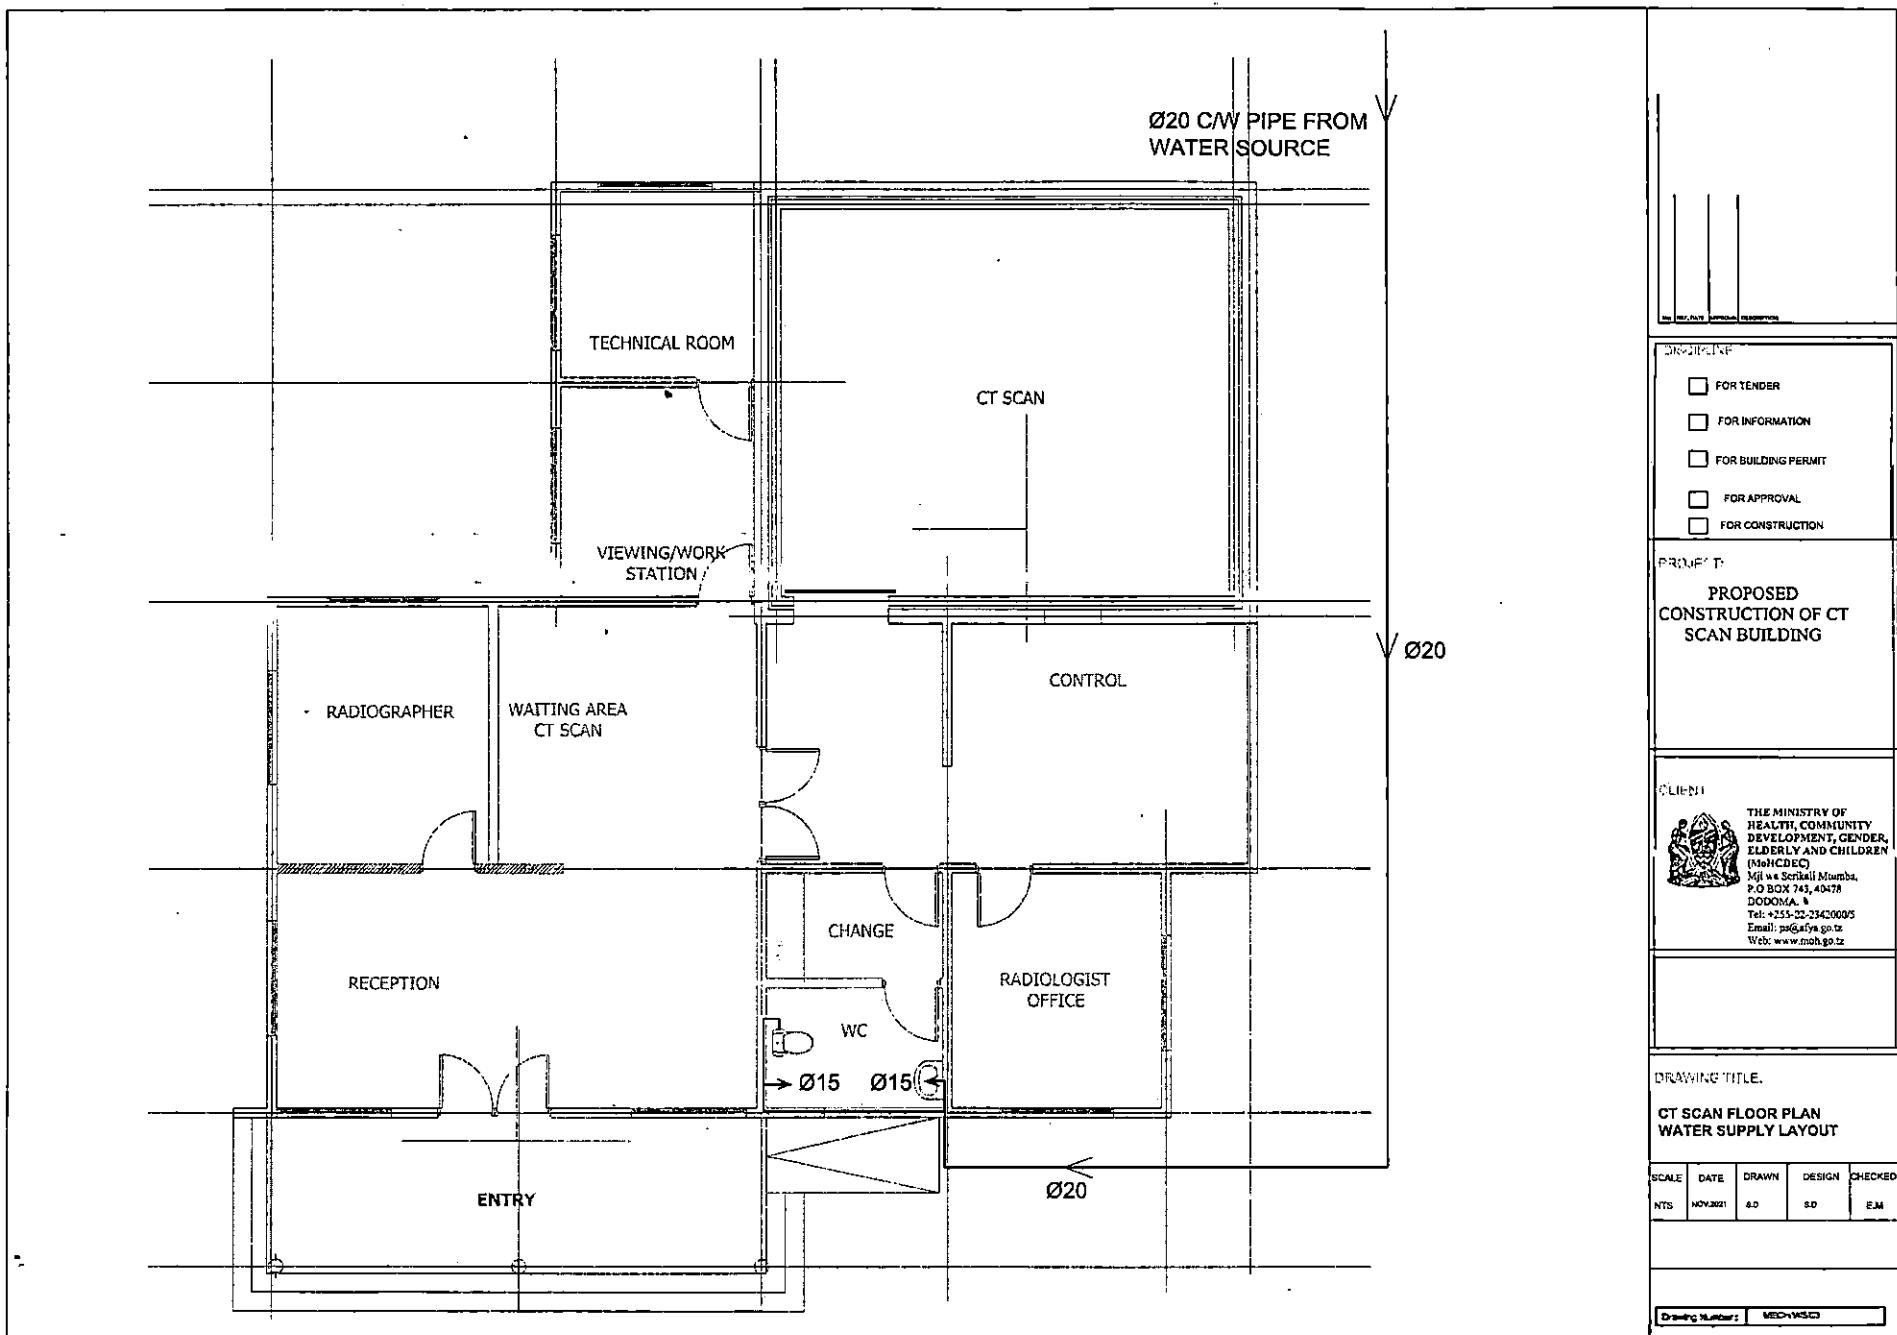

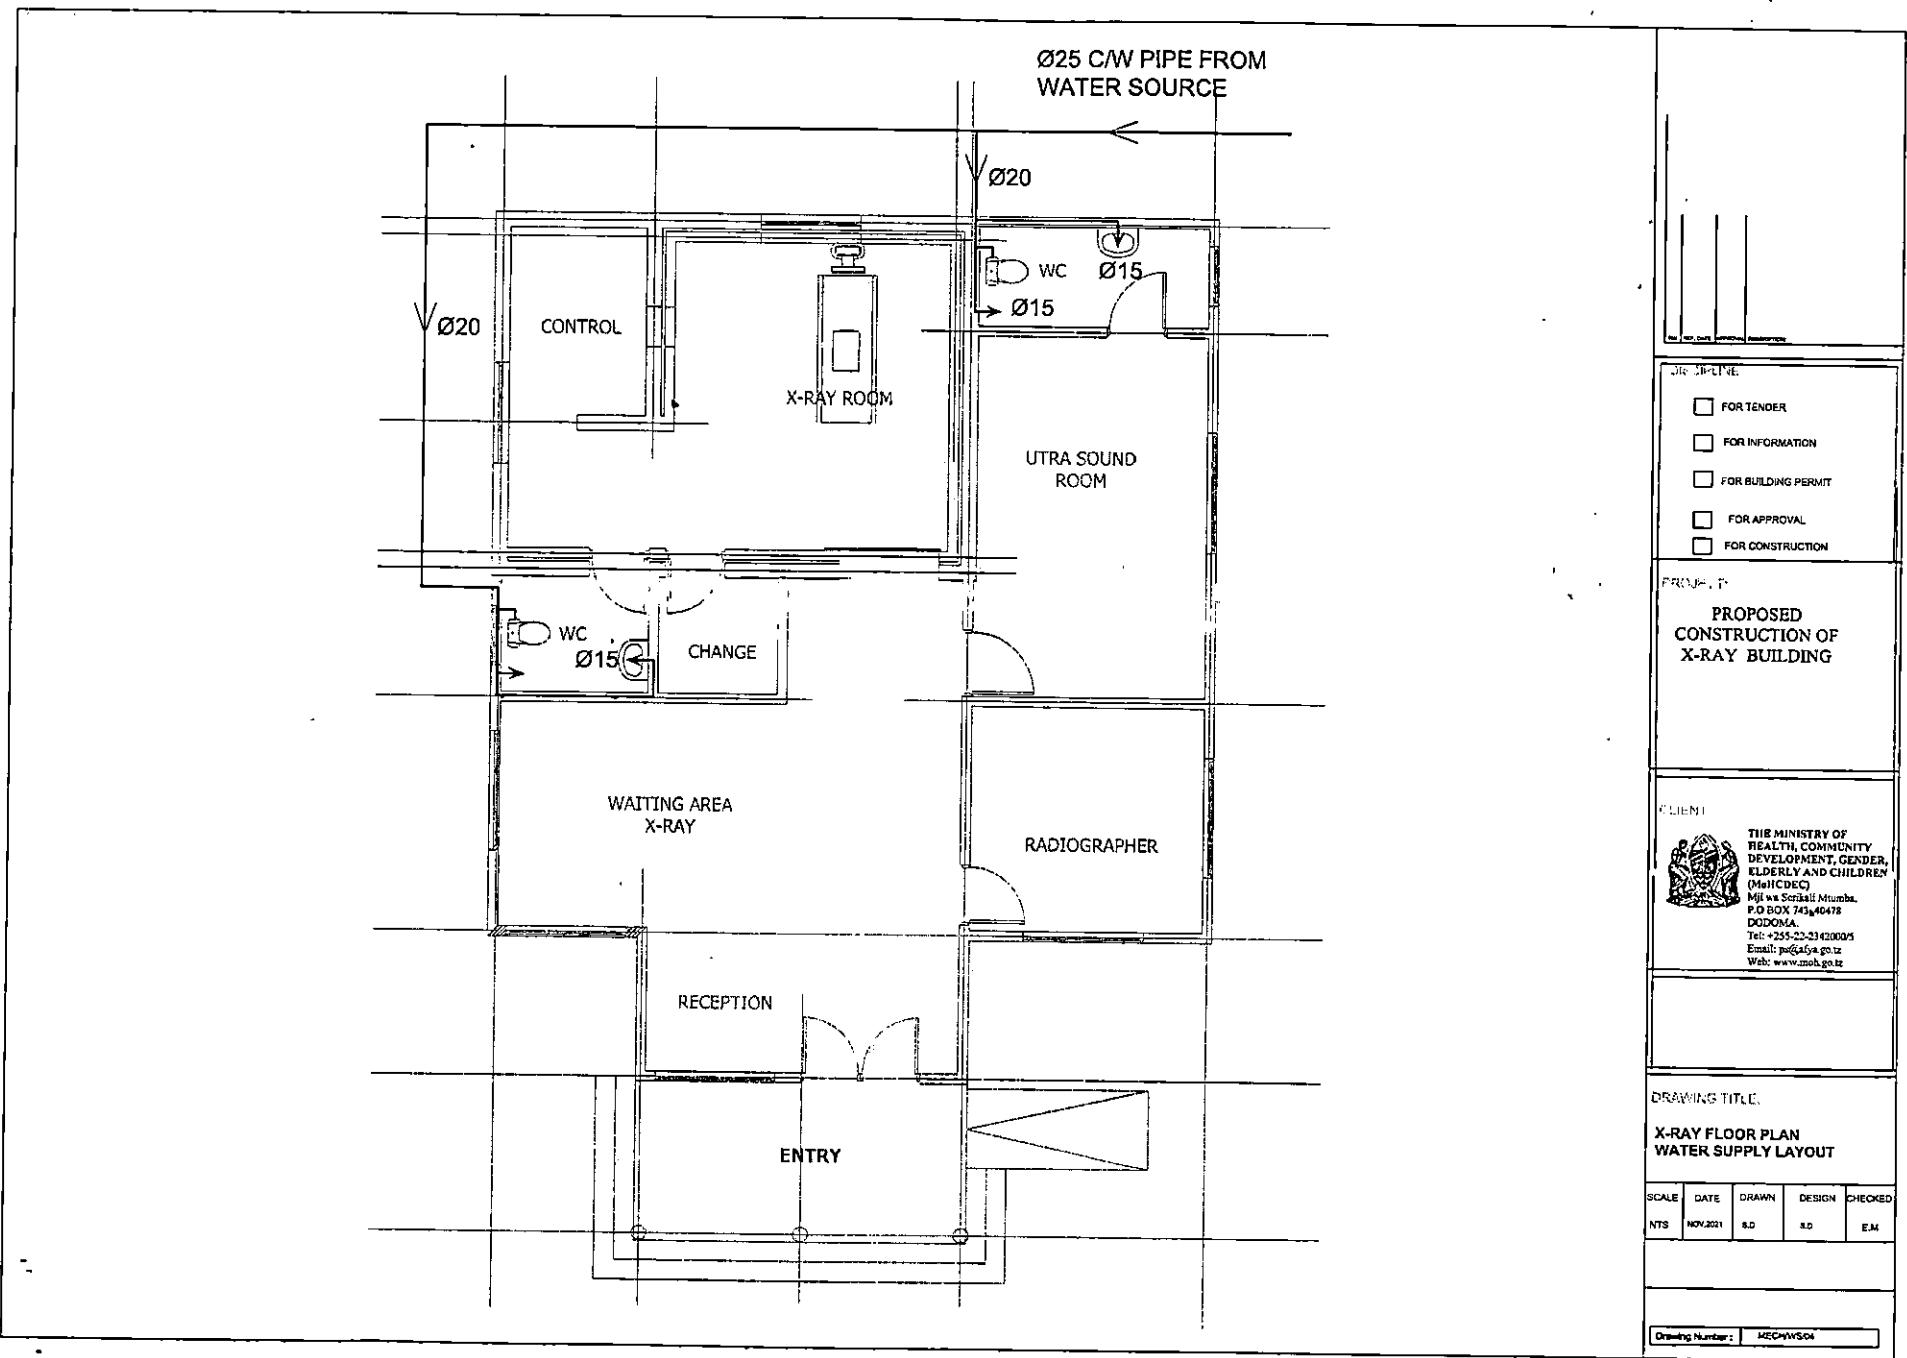

LEGEND FOR WASTE WATER DRAINAGE SYSTEM

S/No.	SYMBOLS/ABREVIATIONS.	DESCRIPTION
1	—	SOIL WATER DRAINAGE PIPELINE
2	—	WASTE WATER DRAINAGE PIPELINE
3	MH	MANHOLE
4	WC	SHOWER/ WATER CLOSET
5	FD	FLOOR DRAIN

NOTES

1. PIPE FITTINGS

All pipes and fittings to be uPVC pipes class 'B'

2. PIPE SIZE

Pipes from WC should be Ø100.

Pipes from HWB and Kitchen sinks should be Ø50.

Pipes from manholes to manholes are Ø100


3. SLOPE

The Slope between manholes is 1% (1:100)

4. MANHOLE DESCRIPTIONS

Manhole size: 600 x 600 internally - Depth to depend on the level in consideration

Gully trap size: 200 x 200 x 200 internally for light duty.

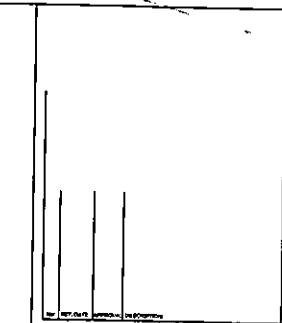

FOR TENDER
FOR INFORMATION
FOR BUILDING PERMIT
FOR APPROVAL
FOR CONSTRUCTION

PROJECT
PROPOSED
CONSTRUCTION OF
X-RAY AND CT SCAN
BUILDING


THE MINISTRY OF HEALTH, COMMUNITY DEVELOPMENT, GENDER, ELDERLY AND CHILDREN (MoHCDEC) Mji wa Serikali Mombasa, PO BOX 743, 40478 DODOMA Tel: +254-22-23420005 Email: pg@afya.go.tz Web: www.muhc.go.tz
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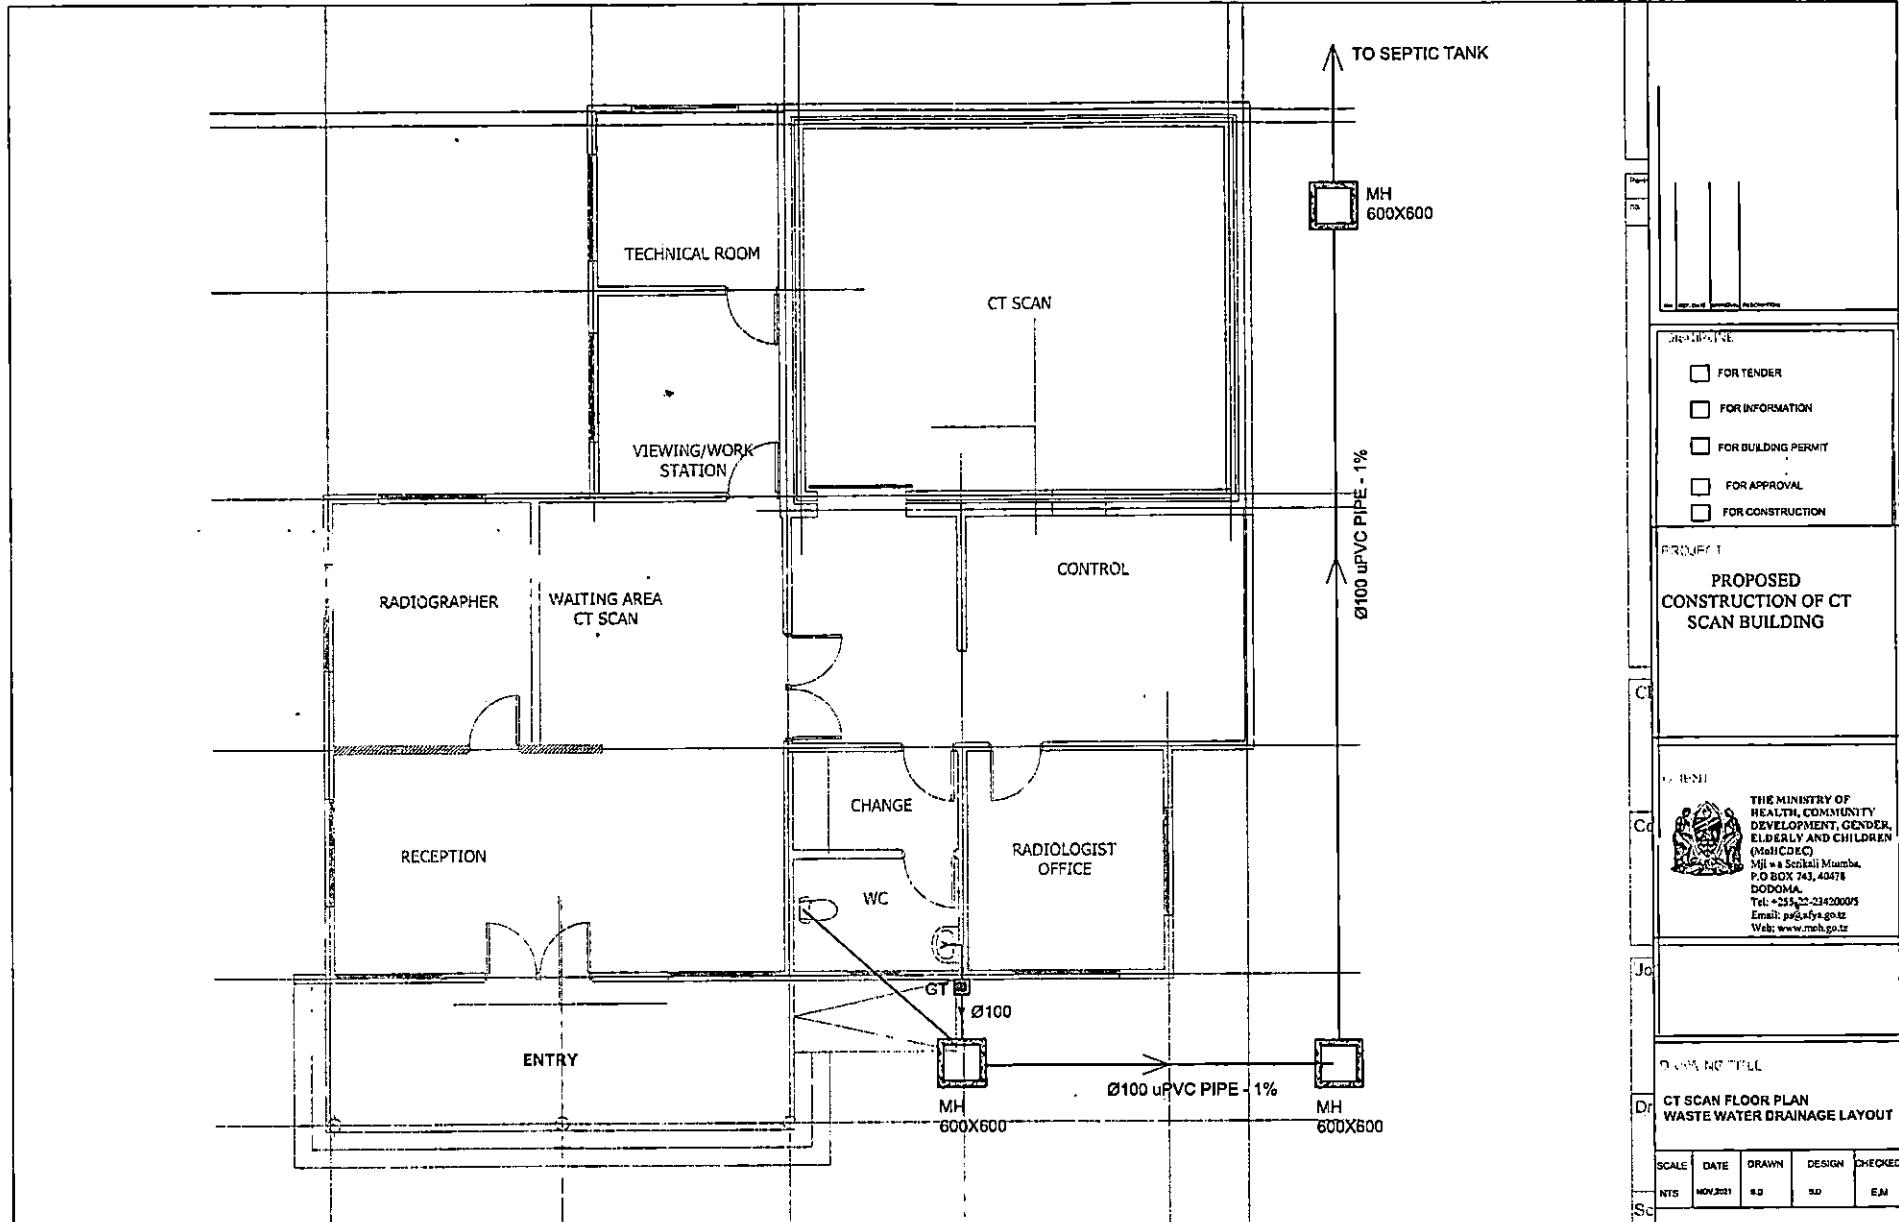
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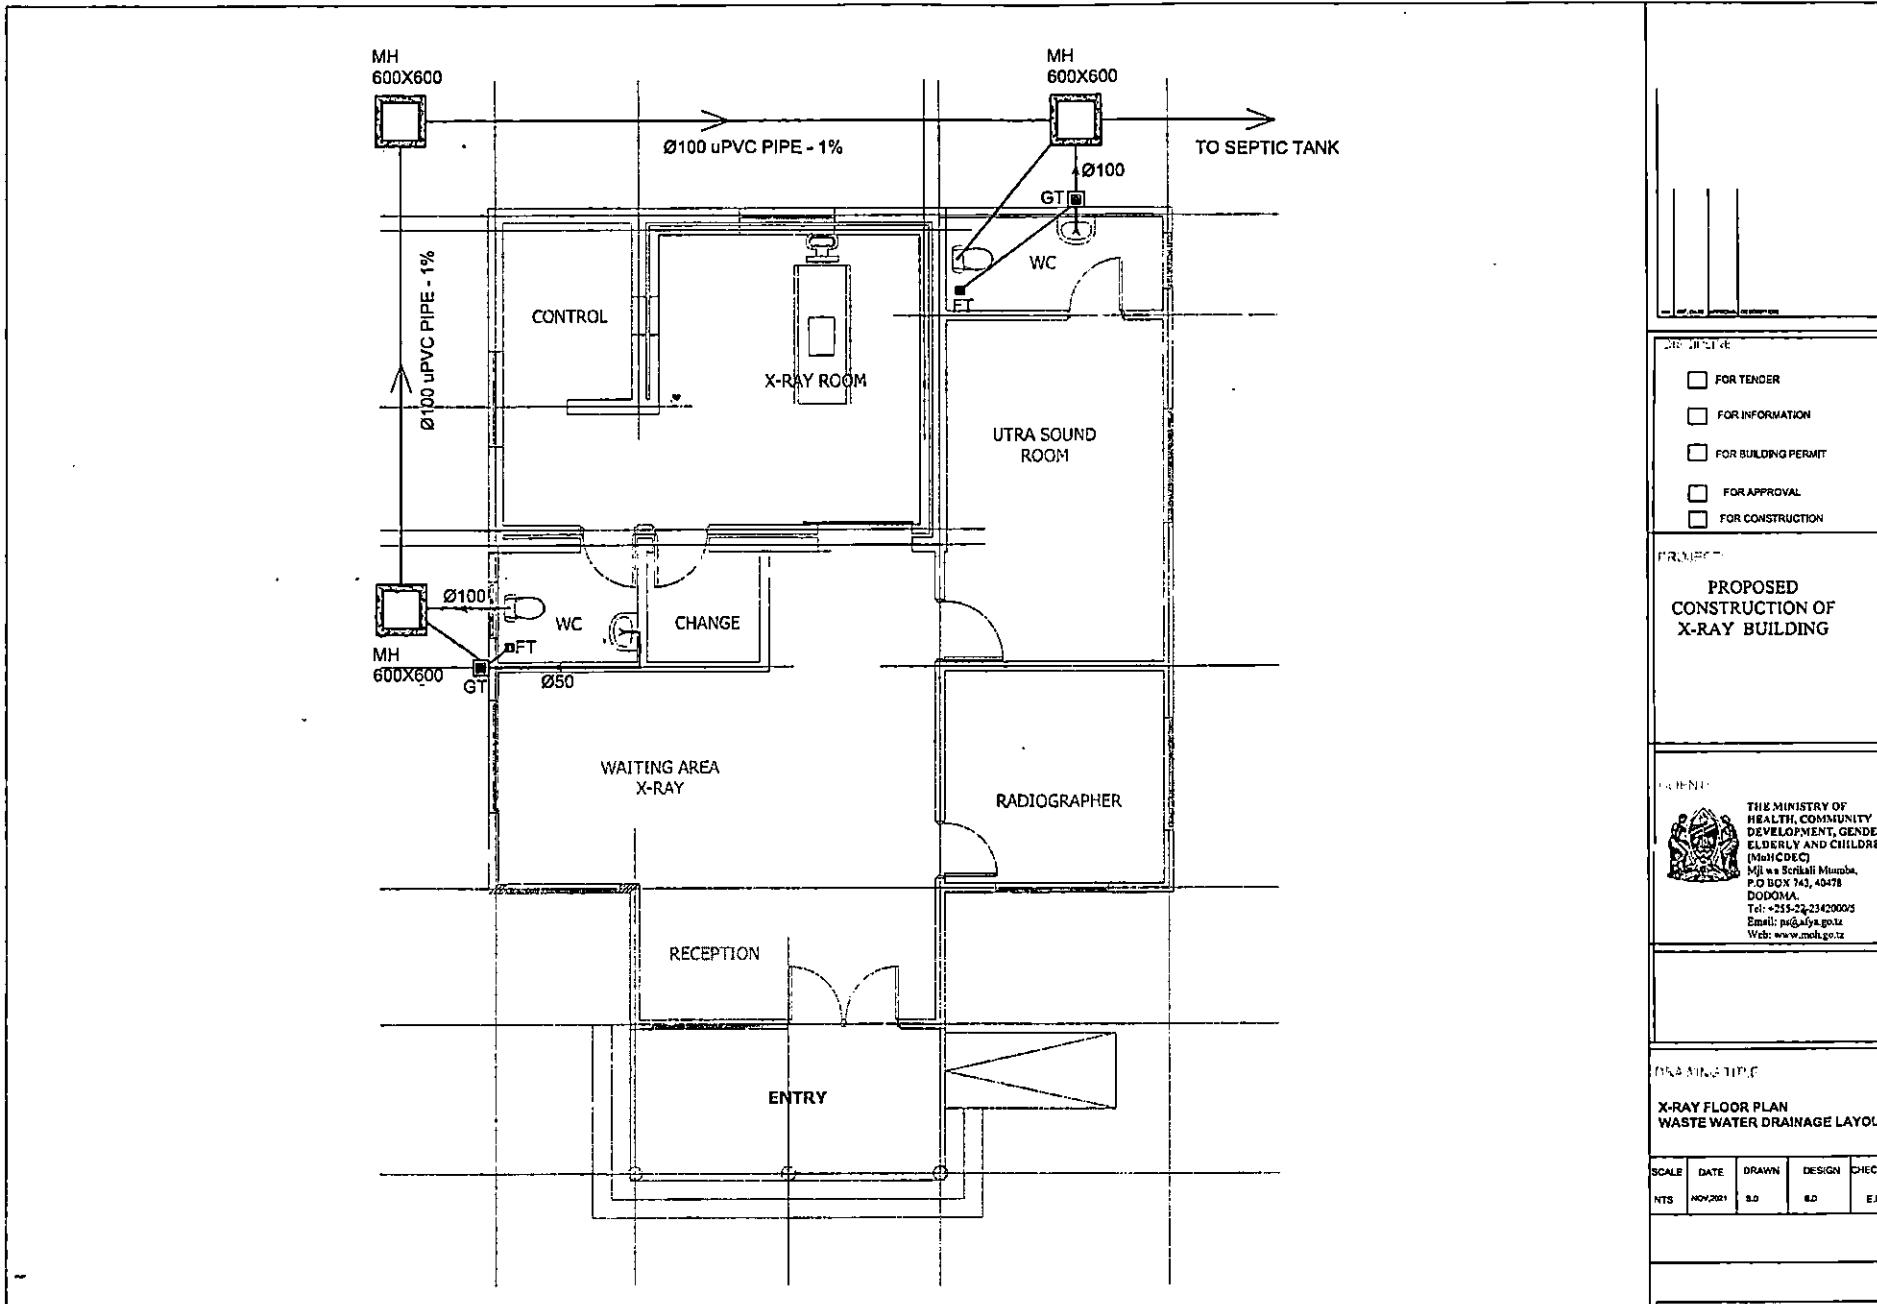
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WASTE WATER DRAINAGE LAYOUT


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NTS	NOV.2021	SD	SD	EM

Drawing Number:	MECH/WWD/1
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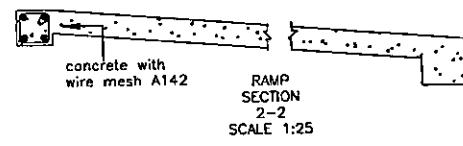
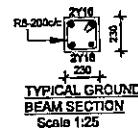
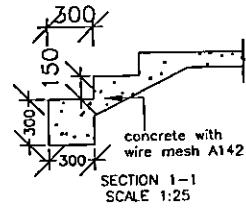
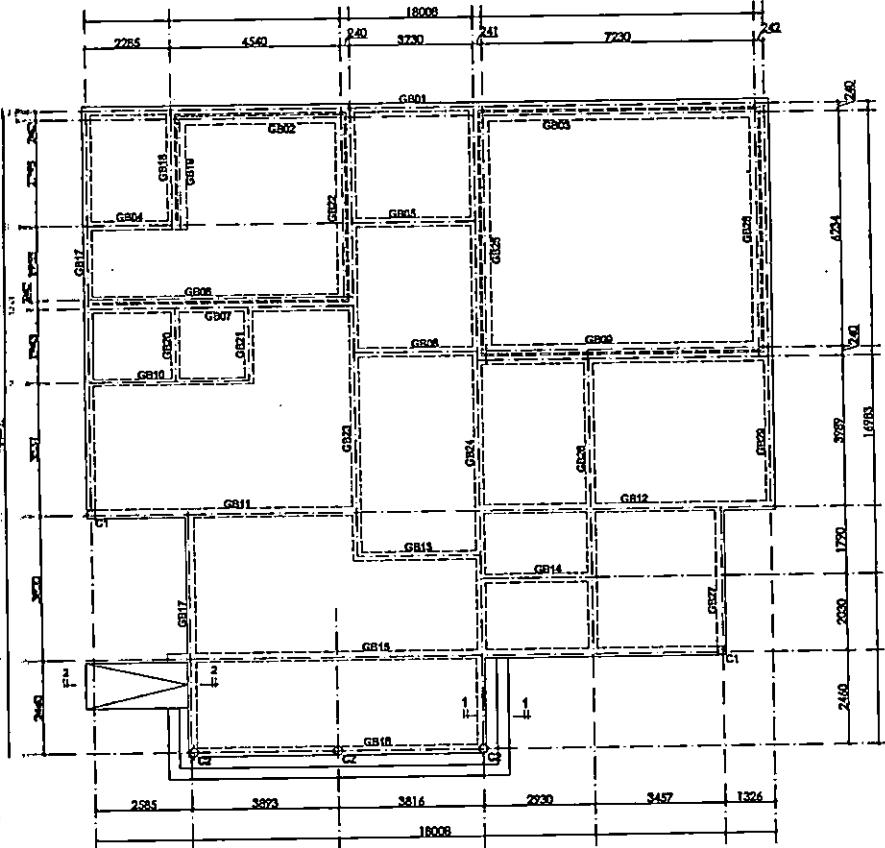
BY ENGINEER
DRAWING SPARE LINE
NAME IN CONSTRUCTION
WITH ARCHITECTURAL AND
STRUCTURAL ENGINEERING
MANAGEMENT

No.	Revised/Initial	Date	Job Ref. CP/001/Ref/21

Client:
MINISTRY OF HEALTH, COMMUNITY DEVELOPMENT,
GERIATRIC, ELDERLY AND CHILDREN
Ministry of Health
Proposed X-RAY AND CT SCAN BUILDING FOR
REGIONAL REFERRAL HOSPITAL

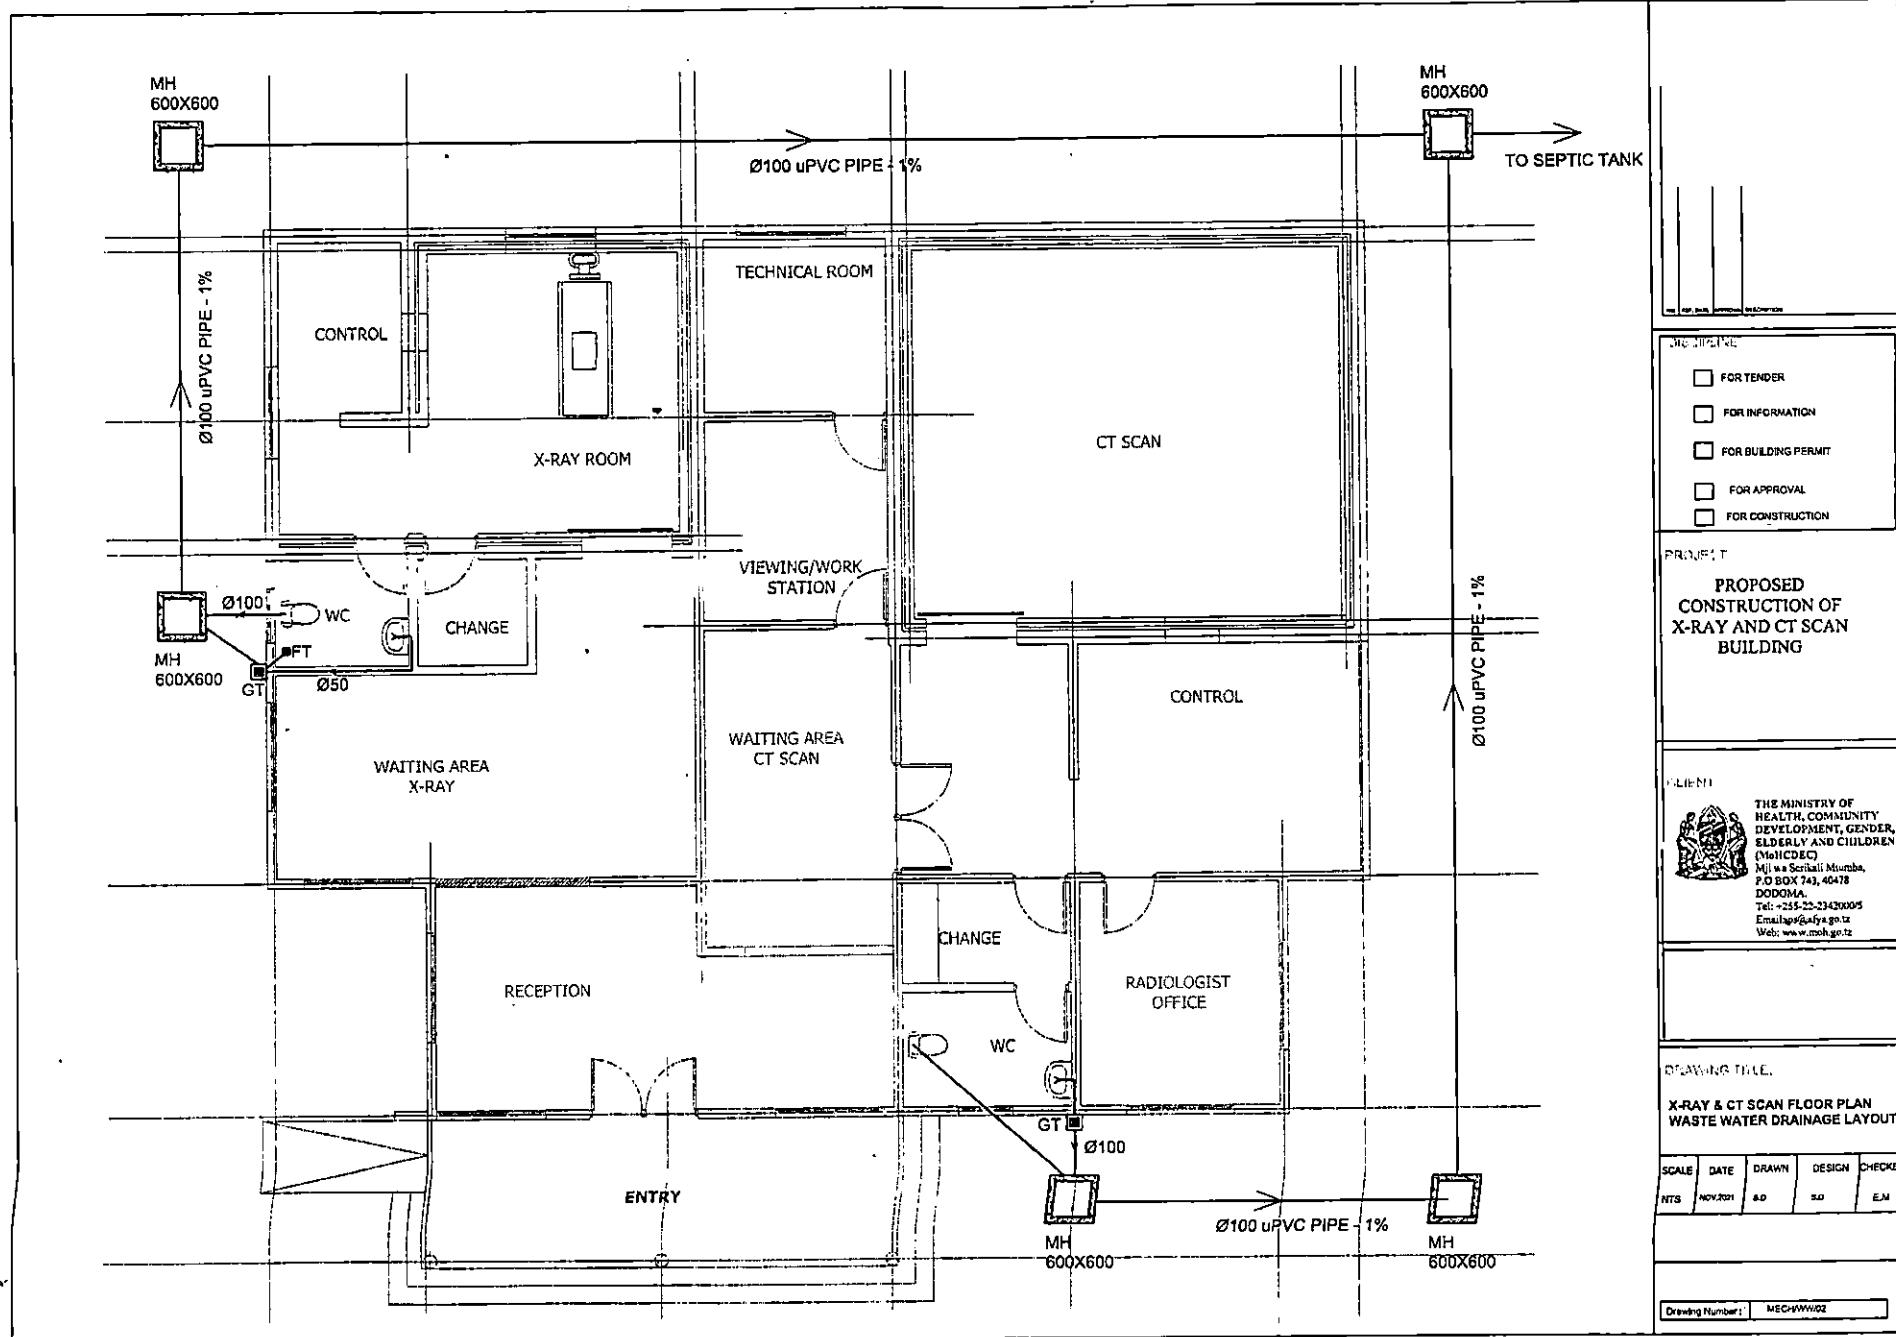Drawing Title:
FOUNDATION PLAN AND SECTIONS

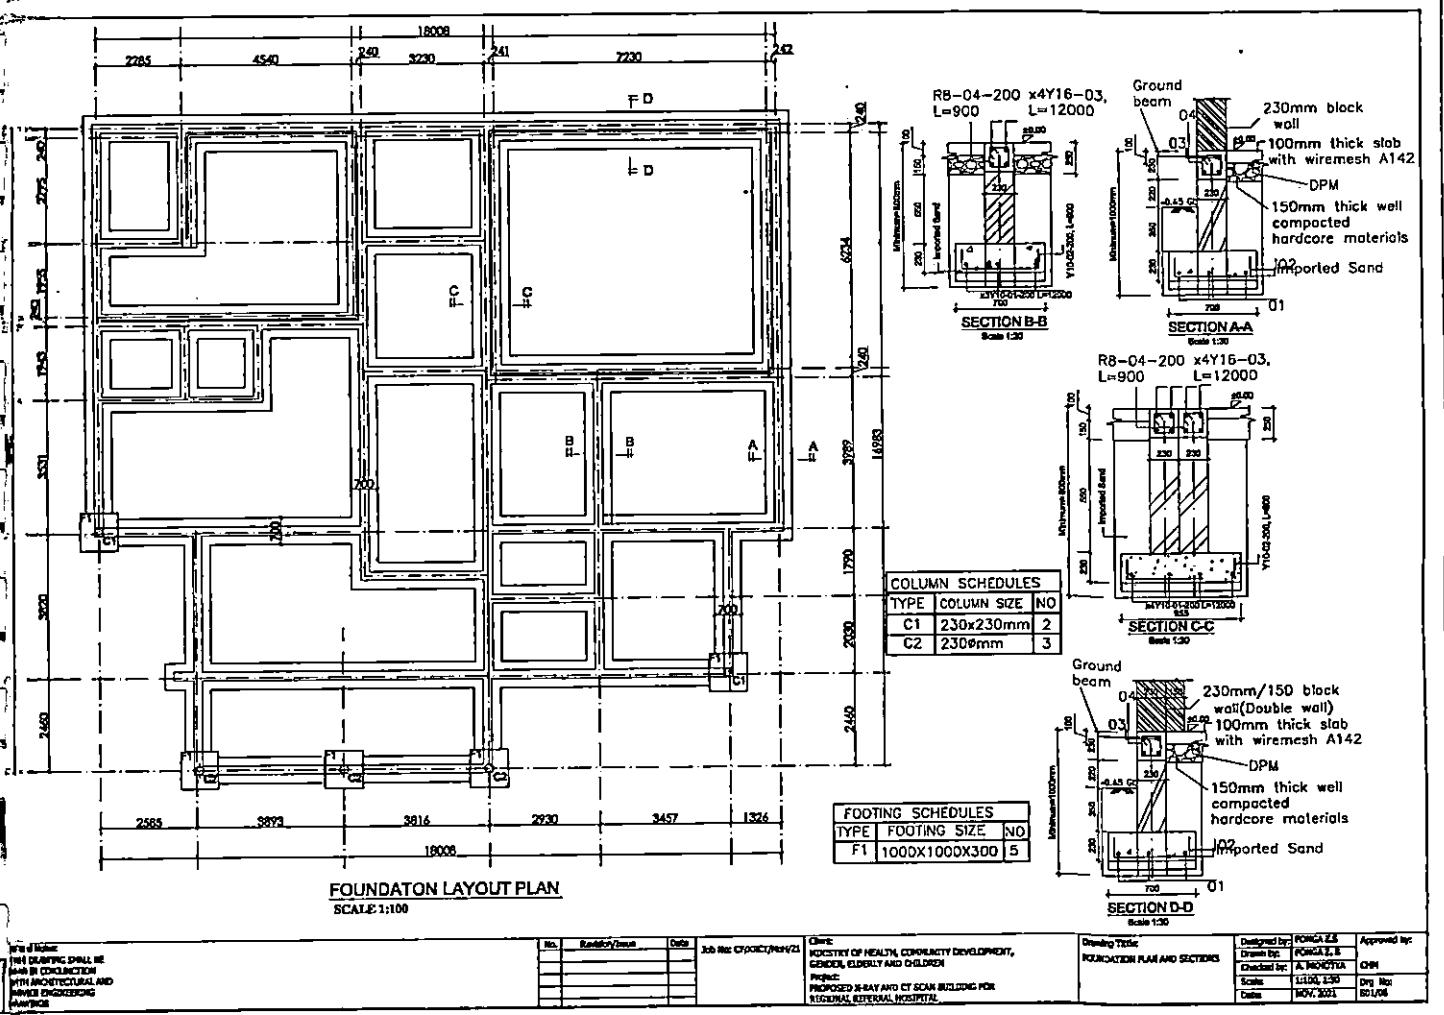Designed by: PONCA Z.S
Drawn by: PONCA Z.S
Checked by: A. MOCTA CHIN
Scale: 1:100, 1:20
Date: NOV. 2021
Dwg No: BS1/04




GROUND FLOOR LAYOUT PLAN


SCALE 1:100

This drawing
shall be
considered
architectural and
structural
works

Ref.	Releated Date	Date	Job No:	Client	Drawing Title	Designed By	Approved By
			OY/2021/05/21	MINISTRY OF HEALTH, COMMUNITY DEVELOPMENT, GERIATRIC, ELDERLY AND CHILDREN	GROUND FLOOR PLAN AND ELEVATIONS	PONCHAL A.R.S	CHIN
				Project: PROPOSED X-RAY AND CT SCAN BUILDING FOR REGIONAL REFERRAL HOSPITAL		Drawn by: REHMAN S	
						Checked by: A. MATHA	
						Scale: 1:100 1:25	Dry Rev: 02/06/2021
						Date: 06/06/2021	

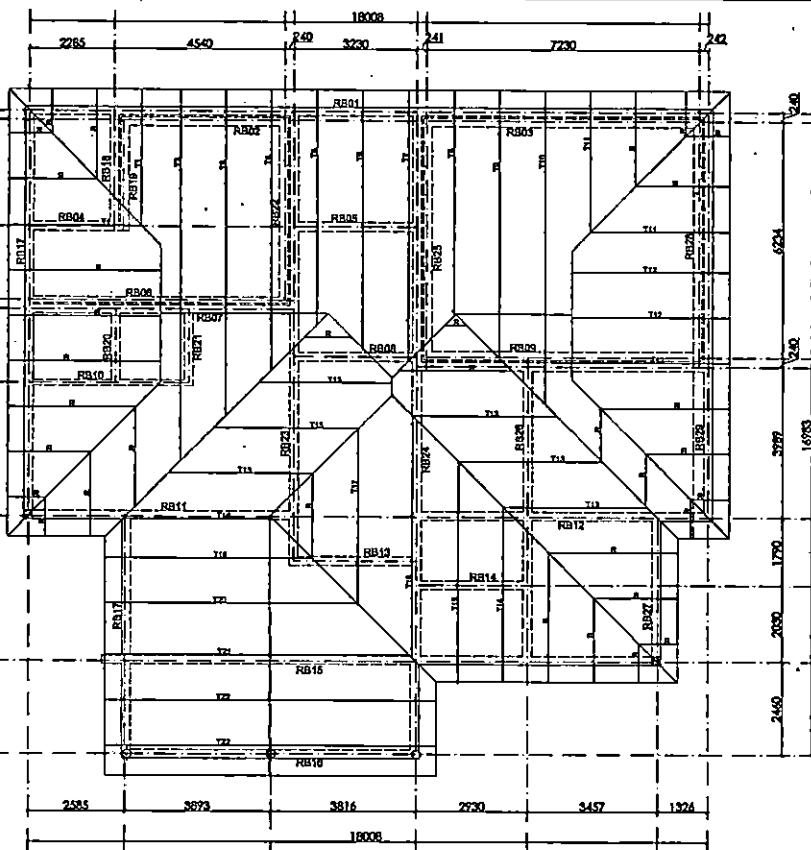

ROOF LAYOUT PLAN
SCALE 1:100

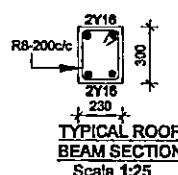

TYPICAL ROOF BEAM SECTION
Scale 1:25

FIRST FLOOR BEAMS SCHEDULE		
TYPE	BEAM SIZE	NO
RB01	230X300	1
RB02	230X300	1
RB03	230X300	1
RB04	230X300	1
RB05	230X300	1
RB06	230X300	1
RB07	230X300	
RB08	230X300	1
RB09	230X300	1
RB10	230X300	1
RB11	230X300	1
RB12	230X300	1
RB13	230X300	1
RB14	230X300	1
RB15	230X300	1
RB16	230X300	1
RB17	230X300	1
RB18	230X300	1
RB19	230X300	1
RB20	230X300	1
RB21	230X300	1
RB22	230X300	1
RB23	230X300	1
RB24	230X300	1
RB25	230X300	1
RB26	230X300	1
RB27	230X300	1
RB28	230X300	1

SCALE:1:25

THIS DRAWING SHALL BE
MADE IN CONSTRUCTION
WITH ARCHITECTURAL AND
STRUCTURAL SERVICES

No.	Revised by/Drawn	Date

Job No: CH24C/Arch/21


Client:
MINISTRY OF HEALTH, COMMUNITY DEVELOPMENT,
GERIATRIC, ELDERLY AND CHILDREN
PROPOSED X-RAY AND CT SCAN BUILDING FOR
REGIONAL REFERRAL HOSPITAL

Drawing Title:
ROOF PLAN


Designed by: PONCA Z.Z.
Checked by: PONCA Z.Z.

Approved by:
PONCA Z.Z.


Drawn by: A. MOYA
Scale: 1:100
Date: NOV. 2021
Drg. No: 602/06

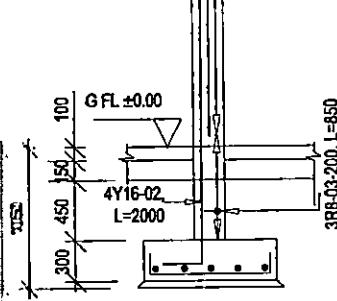


COLUMN CO1, 2Nos)
Scale 1:50

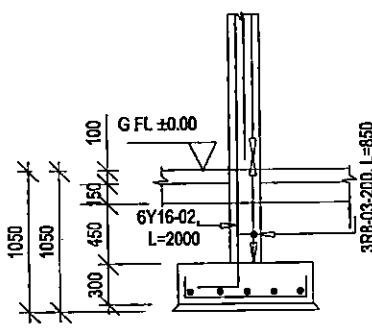


COLUMN CO₂, 3Nos

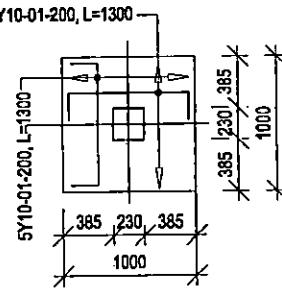

FOOTING F01 (1000X1000X300), 2Nos

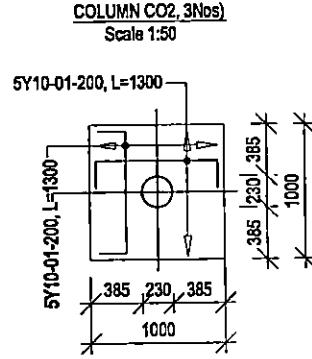


FOOTING F01 (1000X1000X300), 3Nos

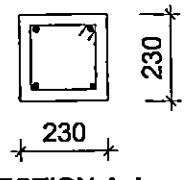


SECTION A-A

Scale 1:25

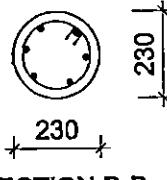


SECTION B-B

Scale 1:25

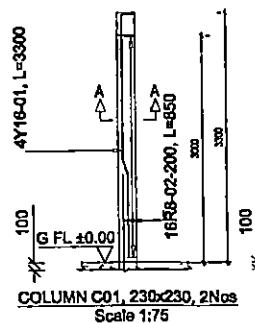

Scale 1:75

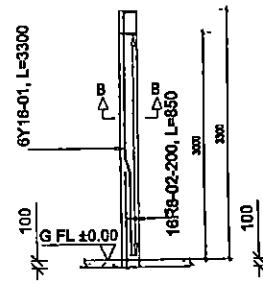

COLUMN C02, 2300, 3N
Scale 1:75

No.	Examination/Result	Date	Job No.	CF/2021/PW/H/21	Client	Drawing Title:	Configured By:	FORGE Z.E.	Approved By:
					INDIORITY OF HEALTH, COMMUNITY DEVELOPMENT, GENDER, ELDERLY AND CHILDREN	COLUMN FOOTINGS AC DETAILS	Created By:	FORGE Z.E.	
					PROPOSED X-RAY AND CT SCAN BUILDING FOR REGIONAL REFERRAL HOSPITAL		Qualified By:	A. PAVITRA	
							Entered By:	ZEB	Drawn By:
							Checked By:	EDV. 2021	SDA/MS

NAME	ADDRESS	TELEPHONE	REGISTRATION EXPIRATION
WILLIAM J. BROWN	1000 N. 10TH ST.	322-1222	1980
WILLIAM J. BROWN	1000 N. 10TH ST.	322-1222	1980
WILLIAM J. BROWN	1000 N. 10TH ST.	322-1222	1980
WILLIAM J. BROWN	1000 N. 10TH ST.	322-1222	1980

CAZIER, EDMUND
Project
RECORDED NAME
REGIONAL REFER


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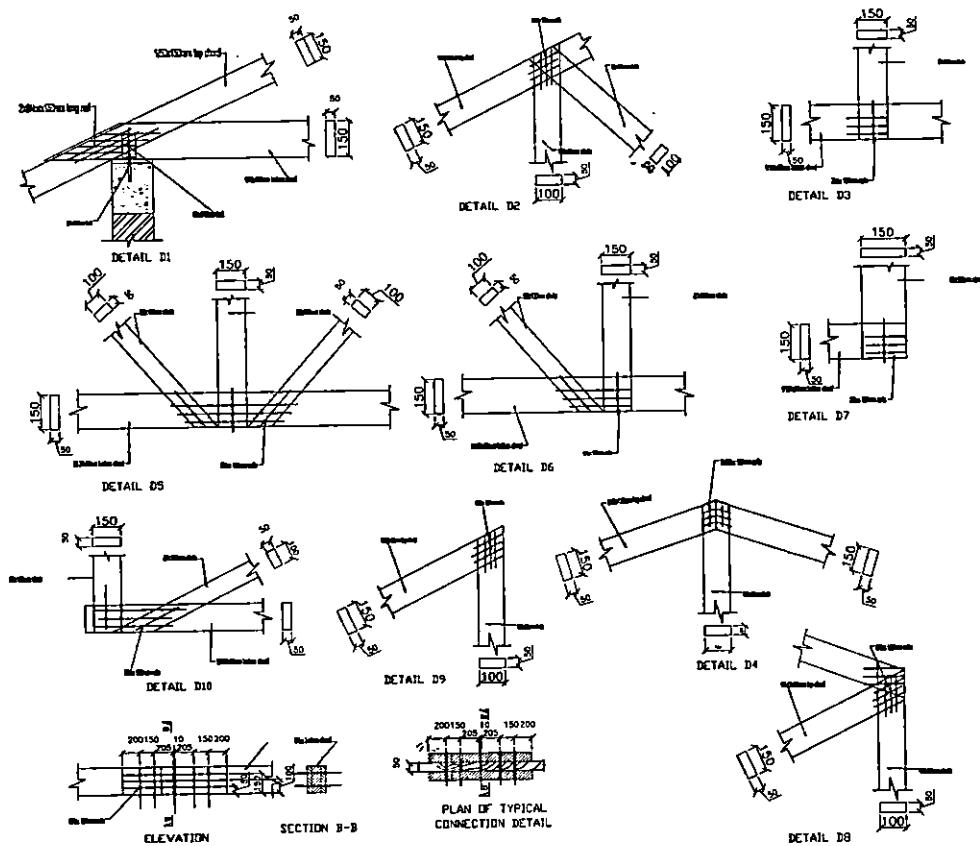
1

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MANUFACTURED
HANSON CHALLEN
BY CONTRACTOR
STRUCTURAL AND
CONCRETE CONTRACTING
Division

No. Revision Date Date Job No. C77/ACT/May/21

OMS
MINISTRY OF HEALTH, COMMUNITY DEVELOPMENT,
GERIOR, ELDERLY AND CHILDREN
PROJECTIONS
PROPOSED MULAT AND CY SOAR BUILDING FOR
REGIONAL REFERRAL HOSPITAL

Drawing Title:
TRUSS CONNECTION DETAILS

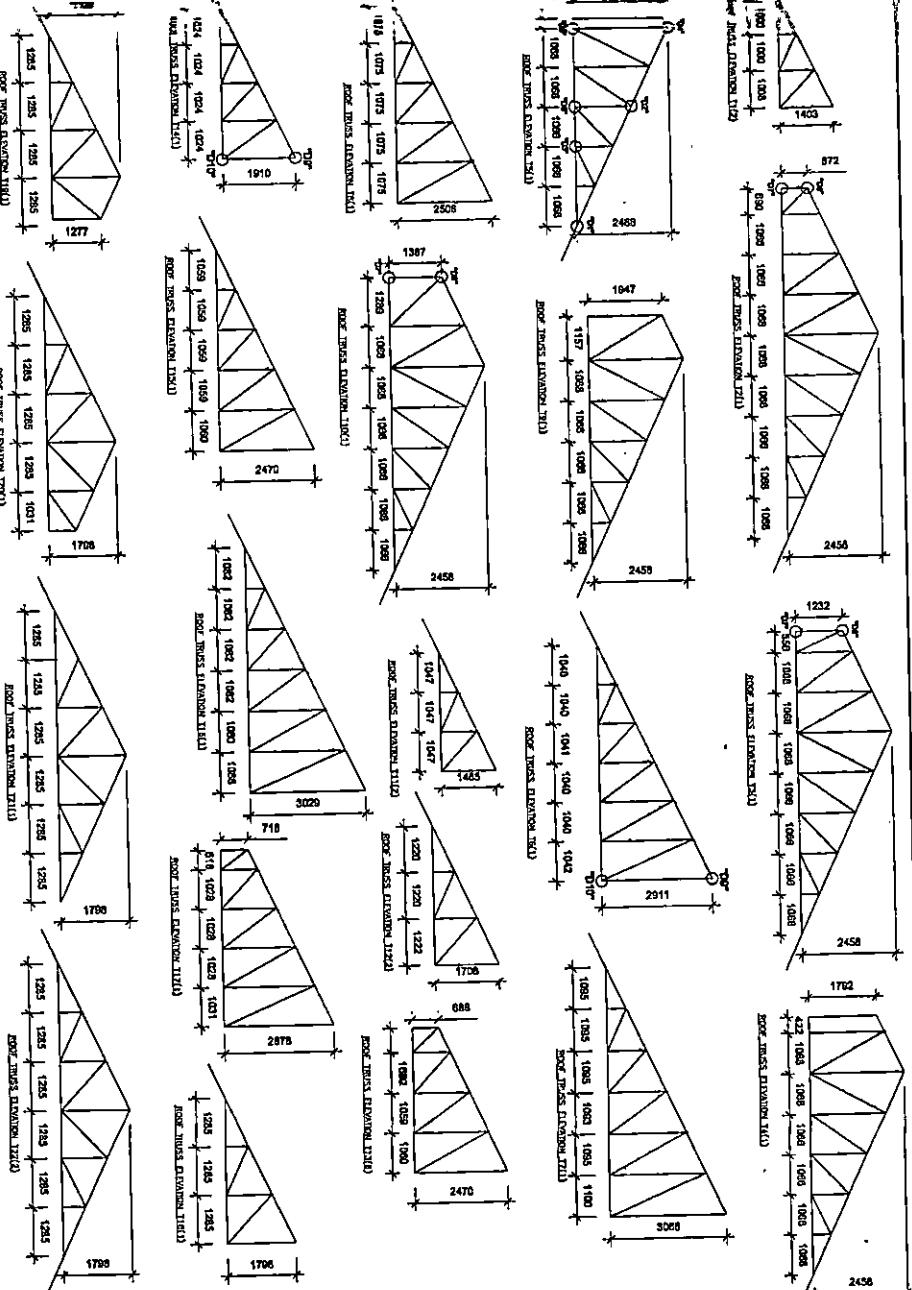Designed by:	PONGA Z. S.	Approved by:	
Drawn by:	PONGA Z. S.	Date:	04/11
Checked by:	A. KUMITA	Draw. No.:	
Revised by:		Date:	12/5
Comments:		Date:	NOV. 2021
			EDISON

PROPOSED CONSTRUCTION X-RAY AND CT-SCAN BLOCK

LIST OF ELECTRICAL DRAWINGS

S/No.	DESCRIPTION	DRAWING No.	DATE/REV.
1.	LIST OF ELECTRICAL DRAWINGS	DK/X-RAY & CT-SCAN /ELE/00	NOV, 2021
2	LIST OF ELECTRICAL LEGEND	DK/X-RAY & CT-SCAN /ELE/01	NOV, 2021
3	FLOOR LIGHTING LAYOUT	DK/X-RAY & CT-SCAN /ELE/02	NOV, 2021
4	FLOOR POWER AND ICT LAYOUT	DK/X-RAY & CT-SCAN /ELE/03	NOV, 2021
5	FLOOR DISTRIBUTION BOARD	DK/X-RAY & CT-SCAN /ELE/04	NOV, 2021

Project No:	DK/XRAY & CT-SCAN/ELE/00
Category:	<input type="checkbox"/> FOR TENDER <input type="checkbox"/> FOR INFORMATION <input type="checkbox"/> FOR BUILDING PERMIT <input type="checkbox"/> FOR APPROVAL <input type="checkbox"/> FOR CONSTRUCTION
Project Title:	PROPOSED CONSTRUCTION OF X-RAY & CT-SCAN BLOCK
Client:	 <p>THE MINISTRY OF HEALTH, COMMUNITY DEVELOPMENT, GENDER, ELDERLY AND CHILDREN (MOHCEDE) MoHcede Special Advisor, P.O. Box 30777, Dar es Salaam, Tanzania. Tel: +255-22-22420005 Email: mohcede@moht.tz www.mohce.de</p>
Drawing Title:	LIST OF ELECTRICAL DRAWINGS
Scale:	1:500
Date:	10/11/2021
Drawn:	DK/XRAY & CT-SCAN/ELE/00
Design:	DK/XRAY & CT-SCAN/ELE/00
Checked:	E.M
Drawing Number: DK/XRAY & CT-SCAN/ELE/00	

ELECTRICAL LEGEND AND GENERAL NOTES

ELECTRICAL LAYOUT		INDUSTRIAL HEIGHTS (in.)	GENERAL NOTES:
1	UPRIGHT SURFACE MOUNTED LINE LIGHT WITH FLUORESCENT 12W BULB AND ELECTRIC THERMAL PROTECTOR. 120V AC. 100W MAX. DIRECT BY CABLE TYPE OR APPROVED EQUIVALENT.	60 INCH	1. THE ELECTRICAL INSTALLATIONS SHALL COMPLY WITH IEC VISION REGULATIONS 17 EDITION 2016 PART 3000. IMPER CIRCUIT ARRANGEMENTS AND DOWNSUPPORT LINES, BILHES AND REGULATORS.
2	UPRIGHT SURFACE MOUNTED LINE LIGHT WITH FLUORESCENT 12W BULB AND ELECTRIC THERMAL PROTECTOR. 120V AC. 100W MAX. DIRECT BY CABLE TYPE OR APPROVED EQUIVALENT.	60 INCH	2. THE INDUSTRIAL INSTALLATIONS SHALL BE CAPTURED OUT UNTIL PVC INSULATED COPPER CABLES DRAWN INTO CONCRETE CONDUITS, CABLE TRAYS, TRUNKING AND DUCTS.
3	UPRIGHT SURFACE MOUNTED LINE LIGHT WITH FLUORESCENT 12W BULB AND ELECTRIC THERMAL PROTECTOR. 120V AC. 100W MAX. DIRECT BY CABLE TYPE OR APPROVED EQUIVALENT.	60 INCH	3. SOCKET OUTLET, TV OUTLETS AND TELEPHONE POINTS SHALL BE REROUTED AT 300MM HTL.
4	UPRIGHT SURFACE MOUNTED DOWNLIGHT DECORATIVE 12W BULB/LED/FITTING FORGED SURFACE SPOTLIGHT. 120V AC. 100W MAX. DIRECT BY CABLE TYPE OR APPROVED EQUIVALENT.	60 INCH	4. ALL WIRING ACCESORIES SHALL BE MOUNTED OR PVC HOLES IN STEEL BOXES ARE NOT ACCEPTABLE.
5	UPRIGHT SURFACE MOUNTED DOWNLIGHT DECORATIVE 12W BULB/LED/FITTING FORGED SURFACE SPOTLIGHT. 120V AC. 100W MAX. DIRECT BY CABLE TYPE OR APPROVED EQUIVALENT.	60 INCH	5. OF SWITCHES AND LIGHTING SWITCHES SHALL BE MOUNTED AT MINIMUM HTL.
6	UPRIGHT SURFACE MOUNTED DOWNLIGHT DECORATIVE 12W BULB/LED/FITTING FORGED SURFACE SPOTLIGHT. 120V AC. 100W MAX. DIRECT BY CABLE TYPE OR APPROVED EQUIVALENT.	60 INCH	6. EACH AC SHALL HAVE A 2M OF JUMPS BUNDLES CLOSE TO THE DOOR UNIT AT LEAST 1M ABOVE THE FLOOR LEVEL.
7	UPRIGHT SURFACE MOUNTED DOWNLIGHT DECORATIVE 12W BULB/LED/FITTING FORGED SURFACE SPOTLIGHT. 120V AC. 100W MAX. DIRECT BY CABLE TYPE OR APPROVED EQUIVALENT.	60 INCH	7. THE NUMBER OF CABLE HOODS TO BE DETERMINED BY THE CABLES STABILITY WHICH THAT CONNECTS EARTH ELECTRODE RESISTANCE SHALL NOT EXCEED 3 OHMS.
8	UPRIGHT SURFACE MOUNTED DOWNLIGHT DECORATIVE 12W BULB/LED/FITTING FORGED SURFACE SPOTLIGHT. 120V AC. 100W MAX. DIRECT BY CABLE TYPE OR APPROVED EQUIVALENT.	60 INCH	8. INSTRUMENT BOXES LOCATED OUTSIDE OF SWITCHES AND LIGHT SWITCHES SHALL BE FAIRLY PLACED TO INDICATE THE EIGHT PLATES LAB EROWN IN DRAWINGS.
9	UPRIGHT SURFACE MOUNTED DOWNLIGHT DECORATIVE 12W BULB/LED/FITTING FORGED SURFACE SPOTLIGHT. 120V AC. 100W MAX. DIRECT BY CABLE TYPE OR APPROVED EQUIVALENT.	60 INCH	9. ALL LIGHTING FITTINGS SHALL BE PLACED COMPLETE WITH LAMP OF PROJECT WATTAGE.
10	UPRIGHT SURFACE MOUNTED DOWNLIGHT DECORATIVE 12W BULB/LED/FITTING FORGED SURFACE SPOTLIGHT. 120V AC. 100W MAX. DIRECT BY CABLE TYPE OR APPROVED EQUIVALENT.	60 INCH	10. THE STABILITY OF THE RGB PHASE AS PER SPECIFICATIONS, ANY OTHER RATING OTHER THAN THOSE SPECIFIED SHALL NOT BE ACCEPTED.
11	UPRIGHT SURFACE MOUNTED DOWNLIGHT DECORATIVE 12W BULB/LED/FITTING FORGED SURFACE SPOTLIGHT. 120V AC. 100W MAX. DIRECT BY CABLE TYPE OR APPROVED EQUIVALENT.	60 INCH	11. NO MORE THAN ONE SUB-CIRCUIT CABLES SHALL BE INSTALLED IN ONE CONDUIT.
12	UPRIGHT SURFACE MOUNTED DOWNLIGHT DECORATIVE 12W BULB/LED/FITTING FORGED SURFACE SPOTLIGHT. 120V AC. 100W MAX. DIRECT BY CABLE TYPE OR APPROVED EQUIVALENT.	60 INCH	12. SWITCHES OR OUTLETS WHICH CANNOT BE MOUNTED ON THEIR OWN SOFTS EXCEPT FOR RGB SWITCHES.
13	UPRIGHT SURFACE MOUNTED DOWNLIGHT DECORATIVE 12W BULB/LED/FITTING FORGED SURFACE SPOTLIGHT. 120V AC. 100W MAX. DIRECT BY CABLE TYPE OR APPROVED EQUIVALENT.	60 INCH	13. ALL ELECTRICAL MATERIAL OTHER THAN THOSE SPECIFIED SHALL BE SUBJECT TO APPROVAL FROM THE PURCHASER/BETALLOCATION.
14	UPRIGHT SURFACE MOUNTED DOWNLIGHT DECORATIVE 12W BULB/LED/FITTING FORGED SURFACE SPOTLIGHT. 120V AC. 100W MAX. DIRECT BY CABLE TYPE OR APPROVED EQUIVALENT.	60 INCH	14. THE CONNECTION LINES FOR RGB CIRCUITS AND LIGHTING POINTS ARE FOR GUIDANCE ONLY. THE CONTRACTOR SHALL DETERMINE THE EXACT CONNECTION LINES TAKING INTO ACCOUNT THE TRANSFORMERS AND ROUTES ADAPTED.
15	UPRIGHT SURFACE MOUNTED DOWNLIGHT DECORATIVE 12W BULB/LED/FITTING FORGED SURFACE SPOTLIGHT. 120V AC. 100W MAX. DIRECT BY CABLE TYPE OR APPROVED EQUIVALENT.	60 INCH	15. ALL IV OUTLETS INTERFACES WITH 20MM DIAMETER PVC CONDUIT DESIGNATING FROM A 20MM DIAMETER DOWN PIPE FROM ROOF ELAB.
16	DRAWS TRACES, WALL PLATES	60 INCH	
17	REINFORCING	60 INCH	
18	Cables to register	60 INCH	
19	INSULATION	60 INCH	

- FOR TENDER
- FOR INFORMATION
- FOR BUILDING PERMIT
- FOR APPROVAL
- FOR CONSTRUCTION

REPORT


**PROPOSED
CONSTRUCTION OF
X-RAY & CT-SCAN
BLOCK**




**THE MINISTRY OF
HEALTH, COMMUNITY
DEVELOPMENT, GENDER
ELDERLY AND CHILDREN**
(MACHEC),
Ms. w/ Sekulu Mbende,
P.O BOX 743, 46478
DODOMA.
Tel: +255-22-2142000/1
Email: pms@dyt.go.tz

LIST OF ELECTRICAL LEGEND

SCALE	DATE	DRAWN	DESIGN	CHECKED
1/2"	REVISER	DRAUGHT	DRAUGHT	ENG.
Drawing Number: DW/X-RAY & CT-SCANE/101				

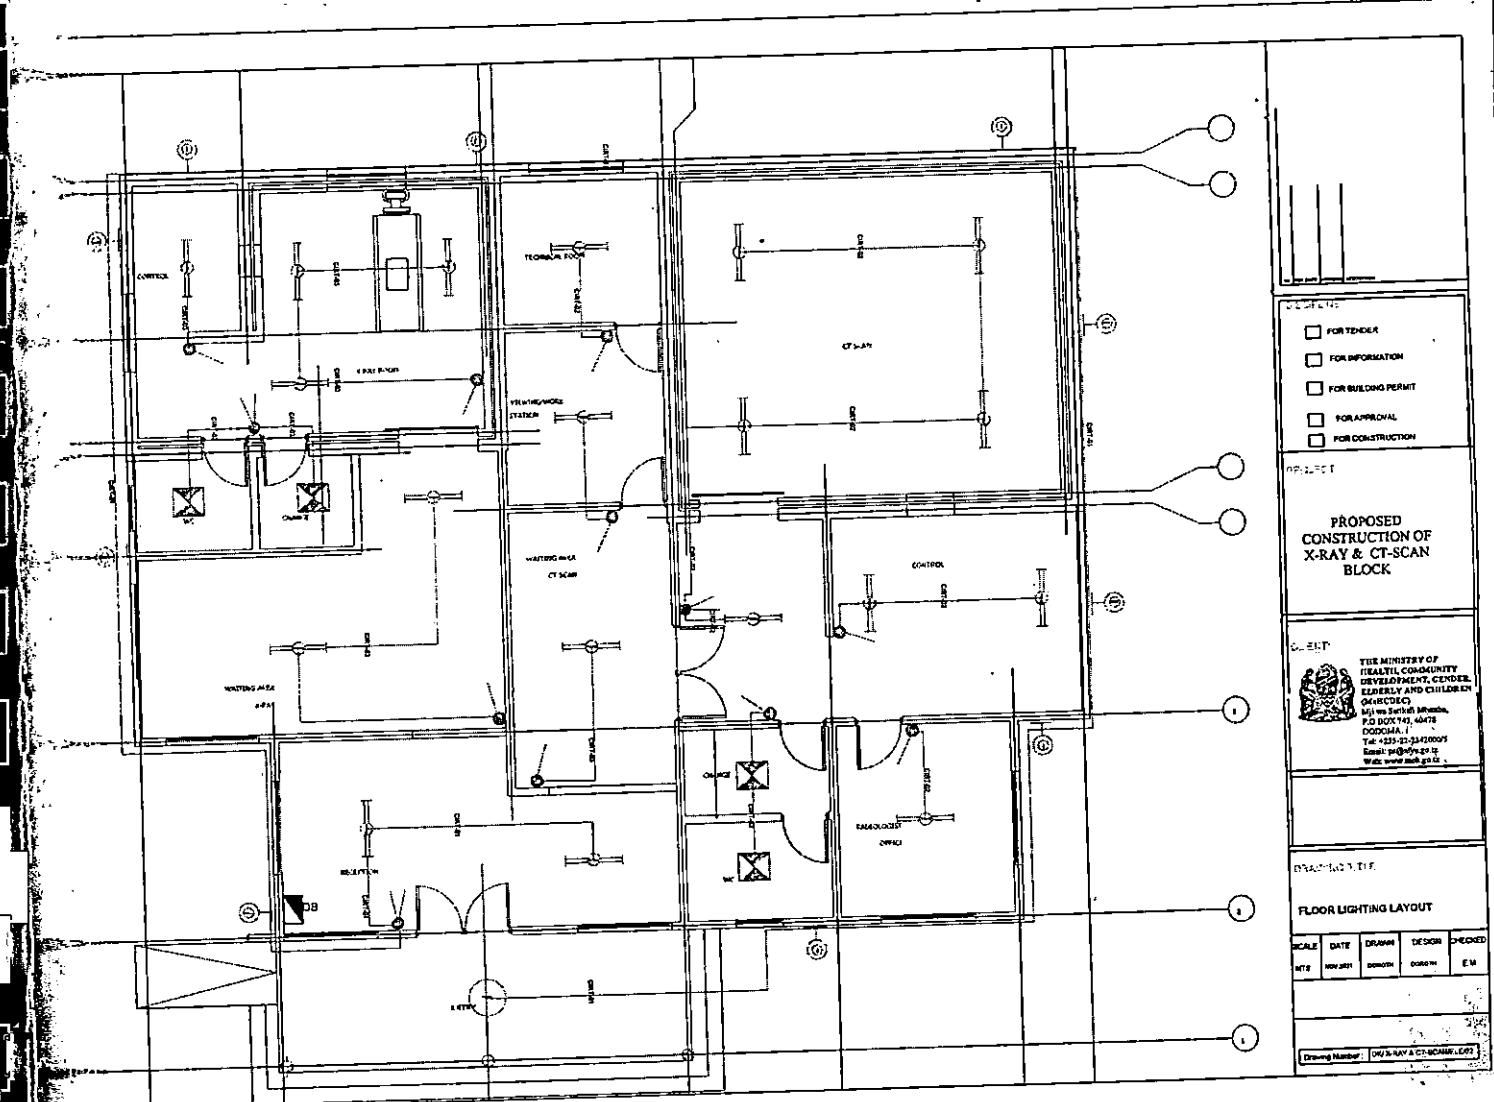

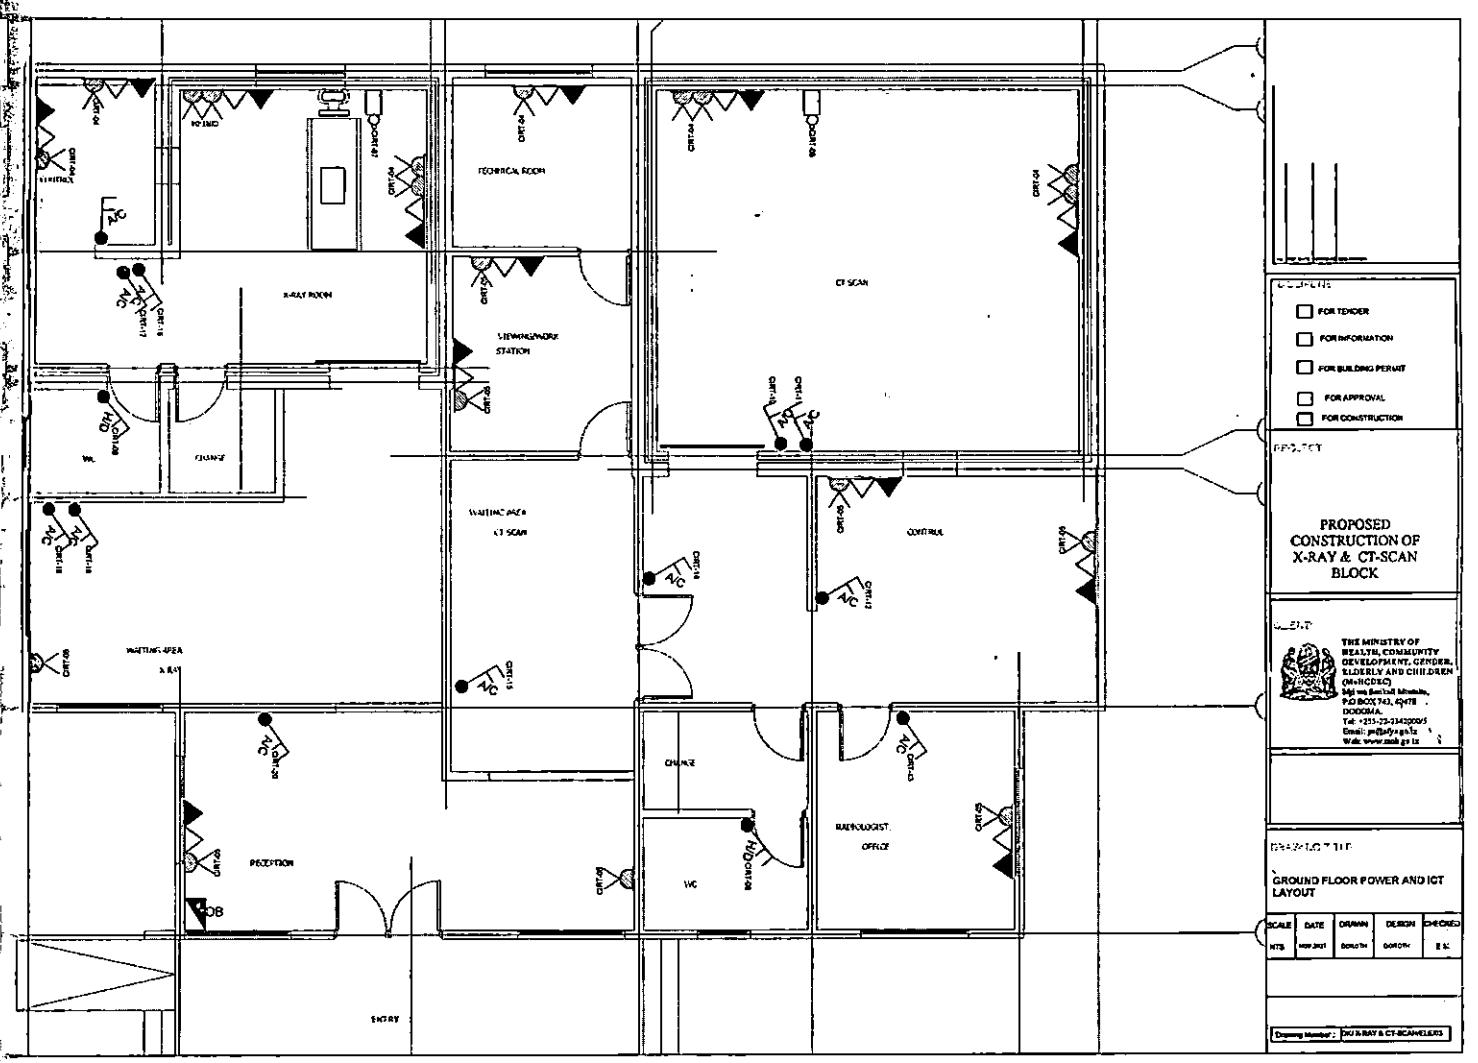

FLOOR DISTRIBUTION BOARD SCHEMATICS

4x25sqmm Cu/PVC/PVC

TRIM TANISCO

1cx16sqmm cu/PVC,

WAY / PHASE NO.	MCB RATING (A)	CABLE SIZE (MM ²)	
1. Y	10	1.5	CIRT-01 LIGHTING
B	10	1.5	CIRT-02 LIGHTING
R	32	2.5	CIRT-03 LIGHTING
2. Y	32	2.5	CIRT-04 S/SOCKETS,RING
B	20	2.5	CIRT-05 S/SOCKETS,RING
R			SPARE
3. Y	45	6	CIRT-06 ISOLATOR
B			
R			
4. Y	45	6	CIRT-07 ISOLATOR
B			
R	20	2.5	CIRT-08 20A DP FOR H/D
5. Y	20	2.5	CIRT-09 20A DP FOR H/D
B	20	2.5	CIRT-10 20A DP FOR A/C
R	20	2.5	CIRT-11 20A DP FOR A/C
6. Y	20	2.5	CIRT-12 20A DP FOR A/C
B	20	2.5	CIRT-13 20A DP FOR A/C
R	20	2.5	CIRT-14 20A DP FOR A/C
7. Y	20	2.5	CIRT-15 20A DP FOR A/C
B	20	2.5	CIRT-16 20A DP FOR A/C
R	20	2.5	CIRT-17 20A DP FOR A/C
8. Y	20	2.5	CIRT-18 20A DP FOR A/C
B	20	2.5	CIRT-19 20A DP FOR A/C
R	20	2.5	CIRT-20 20A DP FOR A/C
9. Y	20		SPARE
B	32		SPARE
R	10		SPARE
10. Y	10		SPARE
B	32		SPARE

R(W)	Y(W)	B(W)
420		
	648	
		648
2400		
	2400	
		2400
		3000
		3000
1000		
	1000	
		1800
1800		
14,020	14,248	11,848

TOTAL LOAD CONNECTED(W) 40,116


SPECIFICATIONS

10-WAY TPN DISTRIBUTION BOARD, WITH INTEGRAL 100A/300-A MCCB
INCOMER AND FINAL CIRCUIT MCB'S AS SPECIFIED, ABB TYPE
DR APPROVED EQUIP.



<input type="checkbox"/> FOR TENDER
<input type="checkbox"/> FOR INFORMATION
<input type="checkbox"/> FOR BUILDING PERMIT
<input type="checkbox"/> FOR APPROVAL
<input type="checkbox"/> FOR CONSTRUCTION

PROPOSED
CONSTRUCTION OF
X-RAY & CT-SCAN
BLOCK

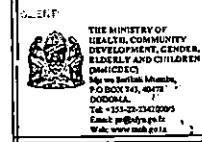

GROUND FLOOR DISTRIBUTION
BOARD SCHEMATIC

SCALE	DATE	DRAWN	DESIGN	CHECKED
MTR	REVISER	DRAFTER	DESIGNER	EM

Drawing Number: CHU/JULAY & CT-SCANS/EL